

CIVIL CONSTRUCTION DOCUMENTS FOR

FAYETTE COUNTY CROSS CREEK TRAIL - CULVERT REPLACEMENT

LAND LOT 23 & 42, 5TH DISTRICT, FAYETTE COUNTY, GA. NOVEMBER 24, 2025 100% DESIGN SUBMITTAL COUNTY PROJECT NUMBER: 21SAJ

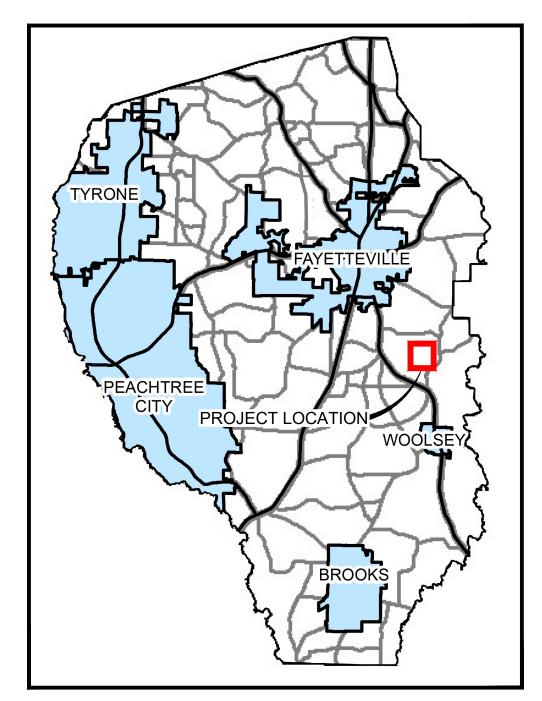

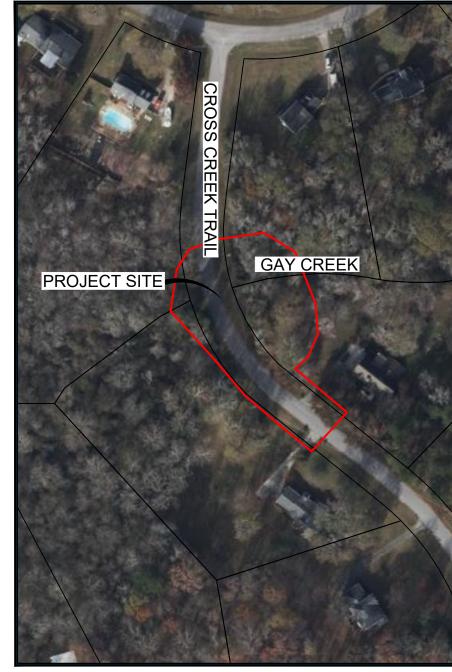

VICINITY MAP SCALE: NTS

		UTILITY NOTIFICATION/RELOCATION CHECKBOX		
UTILITY COMPANY	PLAN PHASE	CONTACT	DATE NOTIFIED	UTILITY RESPONSE
	35% DESIGN	MFLOYD@SOUTHERNCO.COM	12/9/2021	NO RESPONSE
SOUTHERN COMPANY	65% DESIGN	WCBRITTI@SOUTHERNCO.COM	3/11/2022	NO RESPONSE
OOM 7 HVI	95% DESIGN	X2KSTEPH@SOUTHERNCO.COM	7/5/2022	NO RESPONSE
FAYETTE COUNTY	35% DESIGN		12/9/2021	NO RESPONSE
WATER SYSTEM	65% DESIGN	JAMES ROSSER (JROSSER@FAYETTECOUNTYGA.GOV)	3/11/2022	NO RESPONSE
(FCWS)	95% DESIGN		7/5/2022	NO RESPONSE
	35% DESIGN		12/9/2021	NO RESPONSE
COMCAST	65% DESIGN	REGINALD ARNEY (REGINALD_ARNEY@COMCAST.COM)	3/11/2022	NO RESPONSE
	95% DESIGN		7/5/2022	NO RESPONSE
	35% DESIGN		12/9/2021	NO RESPONSE
COWETA-FAYETTE EMC	65% DESIGN	STEVE JONES (STJONES@UTILITY.ORG)	3/11/2022	NO RESPONSE
LIVIO	95% DESIGN		7/5/2022	NO RESPONSE
	35% DESIGN	ANDREWALTON	12/9/2021	NO RESPONSE
ATT	65% DESIGN	ANDRE WALTON AW9750@ATT.COM	3/11/2022	NO RESPONSE
	95% DESIGN			NO RESPONSE
ZAYO	95% DESIGN	KATE.PETERS@COBBFENDLEY.COM	7/5/2022	NO RESPONSE

CLIENT INFORMATION

OWNER CONTACT (24-HR): PHIL MALLON PHONE (770) 313-9855

publicworks@FayetteCountyGA.GOV

CLIENT INFORMATION: FAYETTE COUNTY ENVIRONMENTAL MANAGEMENT 140 STONEWALL AVE. W., SUITE 203, FAYETTEVILLE, GA. 30214

CIVIL DESIGN TEAM

PROJECT MANAGER: CODY OWENBY, P.E. MorganD@pondco.com CIVIL ENGINEER: CODY OWENBY, P.E.

POND AND COMPANY 3500 PARKWAY LANE SUITE 500 PEACHTREE CORNERS, GA 30092 PHONE (678) 336-7740 FAX (678) 336-7744 WEB: www.pondco.com

IT IS THE OWNER'S/DEVELOPER'S RESPONSIBILITY TO BE IN COMPLIANCE WITH APPLICABLE NATIONAL POLLUTION DISCHARGE ELIMINATION SYSTEM (NPDES) PERMIT AND CLEAN WATER ACT REQUIREMENTS.

PROJECT DESCRIPTION:

THE PROJECT CONSISTS OF REMOVING THE EXISTING DETERIORATED QUADRUPLE 72-INCH DIAMETER CMP CULVERTS. EACH CULVERT HAS A LENGTH OF 76-FT. THE CULVERTS ARE TO BE REPLACED WITH A DOUBLE 9' X 9' CONCRETE BOX CULVERT.

PROJECT INFORMATION:

DISTURBED AREA:

IMPERVIOUS SURFACE AREA: 0.05 AC

REFERENCE DATUM:

HORIZONTAL: NAD 1983 (2011) - STATE PLANE COORDINATE SYSTEM

OF GEORGIA - WEST ZONE.

VERTICAL: NAVD 1988.

PROJECT SPECIFICATION:

THE CONTRACTOR SHALL REFER TO AND USE THE SUPPLIED COUNTY PROJECT SPECIFICATIONS. FOR OTHER APPLICABLE STANDARDS OR SPECIFICATIONS, CONTRACTOR TO USE THE CURRENT GDOT APPROVED STANDARD SPECIFICATION CONSTRUCTION OF TRANSPORTATION SYSTEM DOCUMENT FOR THIS PROJECT.

CIVIL INDEX						
SHEET NUMBER	SHEET TITLE					
G-001	CIVIL COVER SHEET					
C-001	LEGEND AND ABBREVIATIONS					
C-002	CIVIL GENERAL NOTES					
V-001	TOPOGRAPHIC SURVEY					
CD101	CIVIL SITE DEMOLITION PLAN					
CG101	SITE AND GRADING PLAN					
CG201	CULVERT PROFILE					
CG301	EASEMENT EXHIBIT					
CE001	EROSION AND SEDIMENT CONTROL NOTES AND LEGEND					
CE002	EROSION AND SEDIMENT CONTROL NOTES AND LEGEND					
CE003	EROSION AND SEDIMENT CONTROL NOTES AND LEGEND					
CE101	EROSION AND SEDIMENT CONTROL INITAL PHASE					
CE201	EROSION AND SEDIMENT CONTROL FINAL PHASE					
CE501	EROSION AND SEDIMENT CONTROL DETAILS					
CE502	EROSION AND SEDIMENT CONTROL DETAILS					
CE503	EROSION AND SEDIMENT CONTROL DETAILS					
CE504	EROSION AND SEDIMENT CONTROL DETAILS					
C-501	CONSTRUCTION DETAILS					
C-502	CONSTRUCTION DETAILS					
C-503	CONSTRUCTION DETAILS					



Peachtree Corners



FAYETTE COUNTY

PROJECT NAME

CROSS CREEK TRAIL CULVERT REPLACEMENT

FAYETTE COUNTY, GA

DRAWING ISSUE

DESIGNED BY: DRAWN BY: CHECKED BY: SUBMITTED BY: DATE: NOVEMBER 24, 2025

PROJECT#

SHEET TITLE

CIVIL COVER SHEET

SHEET NUMBER

G-001

ORIGINAL SHEET SIZE: 22" X 34"

SHEET 1 OF 20

LEFT

LAB

LAM

LATL

LAV

LABORATORY

LATERAL

LAVATORY

LAMINATE OR LAMINATION

DWV

DRAIN, WASTE, AND VENT

3

REFERENCE SYMBOLS LETTER IDENTIFICATION XX-XX DENOTES DRAWING NO WHERE SECTION IS LOCATED SECTION REFERENCE -DENOTES SECTION LETTER IDENTIFICATION SECTION SCALE: - DENOTES DRAWING NO WHERE SECTION IS LOCATED

SECTION TITLE

DENOTES DETAIL NUMBER IDENTIFICATION XX-XX - DENOTES DRAWING NO WHERE DETAIL IS LOCATED

DETAIL REFERENCE

DENOTES DETAIL NUMBER IDENTIFICATION DETAIL SCALE: - DENOTES DRAWING NO WHERE DETAIL IS LOCATED DETAIL TITLE

1. NOT ALL ABBREVIATIONS SHOWN WILL BE USED ON THIS PROJECT.

SHEET NAMING CONVENTION

C-001 2 DIGIT DESCIPLINE DESIGNATOR (IF ONLY ONE LETTER IS USED, THE SECOND LETTER IS REPLACED WITH A DASH "-" AS A PLACEHOLDER)** -1 DIGIT SHEET TYPE DESIGNATOR 0 - GENERAL 1 - PLANS 2 - PROFILES

L 2 DIGIT SEQUENTIAL # (01-99) (FIRST DIGIT INDICATES PLAN TYPE. SECOND DIGIT INDICATES FLOOR)

PROJECT CONTACTS:

CIVIL ENGINEER FOR THIS PROJECT IS: POND & COMPANY 3500 PARKWAY LANE, SUITE 500 PEACHTREE CORNERS, GA 30092 P: (678) 336.7740

CONTACT: CODY OWENBY, P.E.

SURVEYOR FOR THIS PROJECT IS: GEOSURVEY, LTD. 1660 BARNES MILL ROAD MARIETTA, GA 30062 P: (770) 795.9900 CONTACT: BRADLEY D. CASH

3500 Parkway Land Suite 500 Peachtree Corners Georgia 30092

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EXP. 9/10/2027

FAYETTE COUNTY

140 STONEWALL AVE W, STE 203 FAYETTEVILLE, GA. 30214

CLIENT INFORMATION

PROJECT NAME

CROSS CREEK TRAIL **CULVER1** REPLACEMENT

FAYETTE COUNTY, GA

DRAWING ISSUE

MDW/MIA DESIGNED BY: MDW DRAWN BY: COA CHECKED BY: SUBMITTED BY: DATE: NOVEMBER 24, 2025

SHEET TITLE

1210496

LEGEND AND **ABBREVIATIONS**

PROJECT#

SHEET NUMBER

C-001

SHEET 2 OF 20

ORIGINAL SHEET SIZE: 22" X 34"

- 2. ALL LABOR, MATERIALS, AND METHODS OF CONSTRUCTION SHALL BE IN STRICT ACCORDANCE WITH THE MINIMUM ENGINEERING AND CONSTRUCTION STANDARDS ADOPTED BY GEORGIA DEPARTMENT OF TRANSPORTATION STANDARDS AND SPECIFICATIONS AND FAYETTE COUNTY STANDARDS. WHERE CONFLICTS OR OMISSIONS EXIST, FAYETTE COUNTY STANDARDS SHALL DICTATE. SUBSTITUTIONS AND DEVIATION FROM PLANS AND SPECIFICATIONS SHALL BE PERMITTED ONLY WHEN WRITTEN APPROVAL HAS BEEN ISSUED BY THE ENGINEER.
- 3. SHOP DRAWINGS OF ALL MATERIALS BEING USED SHALL BE SUBMITTED TO THE ENGINEER FOR APPROVAL PRIOR TO INSTALLATION
- 4. ALL MATERIALS AND CONSTRUCTION TO BE IN ACCORDANCE WITH THE GEORGIA DEPARTMENT OF TRANSPORTATION STANDARDS AND SPECIFICATIONS AND FAYETTE COUNTY DEVELOPMENT REGULATIONS, LATEST EDITION, UNLESS OTHERWISE WAIVED.
- 5. IT WILL BE THE RESPONSIBILITY OF THE CONTRACTOR TO ENSURE THAT ALL REQUIRED PERMITS ARE OBTAINED AND IN HAND BEFORE BEGINNING ANY CONSTRUCTION. NO CONSTRUCTION OR FABRICATION OF ANY ITEM SHALL BEGIN UNTIL THE CONTRACTOR HAS RECEIVED ALL PLANS AND ANY OTHER DOCUMENTATION FROM ALL OF THE PERMITTING AND ANY OTHER REGULATORY AUTHORITIES. ANY PENALTIES, STOP WORK ORDERS OR ADDITIONAL WORK RESULTING FROM THE CONTRACTOR BEING IN VIOLATION OF THE REQUIREMENTS ABOVE, SHALL BE FULLY BORNE BY THE CONTRACTOR.
- THE LOCATION OF ALL EXISTING UTILITIES AND STORM DRAINAGE SHOWN ON THE PLANS HAVE BEEN DETERMINED FROM THE BEST INFORMATION AVAILABLE AND ARE GIVEN FOR THE CONVENIENCE OF THE CONTRACTOR. THE ENGINEER ASSUMES NO RESPONSIBILITY FOR INACCURACY. PRIOR TO THE START OF ANY CONSTRUCTION ACTIVITY IT SHALL BE THE CONTRACTOR'S RESPONSIBILITY TO NOTIFY THE VARIOUS UTILITIES AND TO MAKE THE NECESSARY ARRANGEMENTS FOR ANY RELOCATION OF THESE UTILITIES WITH THE OWNER OF THE UTILITY. THE CONTRACTOR SHALL EXERCISE CAUTION WHEN CROSSING UNDERGROUND UTILITIES, WHETHER SHOWN ON THE PLAN OR LOCATED BY THE UTILITY COMPANY. ALL UTILITIES WHICH INTERFERE WITH THE PROPOSED CONSTRUCTION SHALL BE BROUGHT TO THE ATTENTION OF THE ENGINEER FIRST. ANY FEES ASSOCIATED WITH UTILITY RELOCATIONS SHALL BE BORNE IN ACCORDANCE WITH RESPECTIVE UTILITY COMPANY STANDARDS. IT IS REQUESTED UTILITY COMPANIES MOVE THEIR PARTICULAR UTILITIES. ANY DELAY OR INCONVENIENCE CAUSED TO THE CONTRACTOR BY THE RELOCATION OF THE VARIOUS UTILITIES SHALL BE INCIDENTAL TO THE CONTRACT AND NO EXTRA COMPENSATION WILL BE ALLOWED. DIAL 811 BEFORE DIGGING OR CALL 800-282-7411.
- 7. THE CONTRACTOR SHALL SCHEDULE A PRE-CONSTRUCTION MEETING TO BE HELD BETWEEN FAYETTE COUNTY, UTILITIES, ENGINEER OF RECORD, CONTRACTOR AND ANY SUBCONTRACTOR PRIOR TO COMMENCEMENT OF CONSTRUCTION.
- 8. THE SEQUENCE OF CONSTRUCTION SHALL BE SUCH THAT ALL UNDERGROUND INSTALLATIONS OF EVERY KIND, INCLUDING LANDSCAPE SPRINKLERS, SHALL BE PLACED BENEATH THE PAVEMENT AND ITS EDGES PRIOR TO THE CONSTRUCTION OF THE PAVEMENT. THE PAVEMENT SHALL NOT BE CUT WITHOUT PRIOR APPROVAL OF THE ENGINEER.
- 9. THE CONTRACTOR SHALL NOTIFY THE ENGINEER AT LEAST 48 HOURS PRIOR TO BEGINNING CONSTRUCTION AND AT LEAST 48 HOURS HOURS BEFORE REQUIRED INSPECTION ON EACH AND EVERY PHASE OF WORK. THE CONTRACTOR SHALL NOTIFY THE ENGINEER A MINIMUM OF 48 HOURS NOTICE PRIOR TO ANY SCHEDULED TESTING. NO PRESSURE TESTING, OR FINAL TESTING WILL BE ACCEPTED UNLESS WITNESSED BY THE ENGINEER'S REPRESENTATIVE. THE CONTRACTOR IS REQUIRED TO NOTIFY 48 HOURS TO FAYETTE COUNTY FOR PROOF ROLL, OF GAB PLACEMENT.
- 10. ALL CONTRACTORS, FAYETTE COUNTY REPRESENTATIVES, AND UTILITY COMPANIES ARE RESPONSIBLE FOR THEIR RESPECTIVE SURVEYING AND LAYOUT FROM BENCHMARK PROVIDED ON CONSTRUCTION PLANS. ANY SURVEY MONUMENTATION DISTURBED DURING CONSTRUCTION SHALL BE REPLACED UPON COMPLETION OF THE WORK BY A
- 11. THE CONTRACTOR SHALL BE RESPONSIBLE FOR PREVENTING ANY CONSTRUCTION ACTIVITIES FROM TAKING PLACE OUTSIDE OF THE LIMITS OF CONSTRUCTION SHOWN ON THE PLANS. ANY ON-SITE OR OFFSITE AREAS DISTURBED SHALL BE RESTORED TO ORIGINAL CONDITION OR BETTER.
- 12. THE CONTRACTOR SHALL MAINTAIN A CURRENT SET OF CONSTRUCTION PLANS AND ALL PERMITS ON THE JOB SITE DURING ALL PHASES OF CONSTRUCTION. THE CONTRACTOR SHALL PROVIDE TWO (2) SETS OF RECORD DRAWINGS TO THE ENGINEER OF RECORD WITHIN TWO (2) WEEKS AFTER CONSTRUCTION HAS BEEN COMPLETED ON EACH PHASE.
- 13. TOPOGRAPHIC INFORMATION SHOWN ON THESE PLANS WAS TAKEN FROM SURVEY PROVIDED BY: GEOSURVEY, LTD., DATED: 10-20-2021.
- 14. ANY CONSTRUCTION BEYOND THE RIGHT-OF-WAY AND/OR ESTABLISHED EASEMENT LINES, ONTO ADJACENT PROPERTY, REQUIRES ADJACENT PROPERTY OWNER PERMISSION AND NECESSARY EASEMENTS PRIOR TO PERFORMING ANY WORK. THE CONTRACTOR IS TO VERIFY SUCH EASEMENTS AND PERMISSIONS PRIOR TO DISTURBING ANY OFF-SITE PROPERTY.
- 15. IT IS THE CONTRACTOR'S RESPONSIBILITY TO DETERMINE EXISTING SITE CONDITIONS OF SOIL PRIOR TO N.T.P. CONSTRUCTION TO DETERMINE IF ANY OFF SITE MATERIALS WILL NEED TO BE IMPORTED TO ACHIEVE THE GRADES SPECIFIED ON THE PLANS
- 16. CLEAR AREAS INDICATED SHALL BE COMPLETELY CLEAR OF ALL TIMBER, BRUSH, STUMPS, ROOTS, GRASS, WEEDS, RUBBISH, AND ALL OTHER DEBRIS AND OBSTRUCTIONS RESTING ON OR PROTRUDING THROUGH THE SURFACE OF THE GROUND.
- 17. PRIOR TO BID PREPARATION, THE CONTRACTOR MUST BECOME FAMILIAR WITH THE OVERALL SITE CONDITIONS AND PERFORM ADDITIONAL INVESTIGATIONS AS DETERMINED NECESSARY TO UNDERSTAND THE LIMIT AND DEPTH OF EXPECTED ORGANIC SILT PEAT AREAS, PRESENCE OF ROCK, ADEQUACY OF EXISTING MATERIALS AS FILL, DEWATERING REQUIREMENTS, CLEAN FILL REQUIRED FROM OFFSITE, AND MATERIALS TO BE DISPOSED OF OFFSITE, ALL OF WHICH WILL AFFECT THE PRICING. ANY DELAY, INCONVENIENCE, OR EXPENSE CAUSED TO THE CONTRACTOR DUE TO INADEQUATE INVESTIGATION OF EXISTING CONDITIONS SHALL BE INCIDENTAL TO THE CONTRACT, AND NO EXTRA COMPENSATION WILL BE ALLOWED. THE MATERIALS ANTICIPATED TO BE ENCOUNTERED DURING CONSTRUCTION MAY REQUIRE DRYING PRIOR TO USE AS BACKFILL, AND THE CONTRACTOR MAY HAVE TO IMPORT MATERIALS, AT NO EXTRA COST, FROM OFFSITE TO MEET THE REQUIREMENTS FOR COMPACTION AND PROPER FILL.
- 18. NEITHER OWNER NOR ENGINEER ASSUMES ANY RESPONSIBILITY FOR ERRORS OR MISINTERPRETATIONS RESULTING FROM USE OF INCOMPLETE SETS OF BIDDING DOCUMENTS.

DEMOLITION NOTES

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- 1. THE CONTRACTOR SHALL OBTAIN NECESSARY PERMITS AND LICENSES FOR PERFORMING THE DEMOLITION WORK AND SHALL FURNISH A COPY OF THESE ITEMS TO THE ENGINEER PRIOR TO COMMENCING THE WORK. THE CONTRACTOR SHALL COMPLY WITH THE REQUIREMENTS OF THE PERMITS.
- 2. THE CONTRACTOR SHALL NOTIFY ALL UTILITY COMPANIES OR LOCAL AUTHORITIES FURNISHING GAS, WATER, ELECTRICAL, TELEPHONE, OR SEWER SERVICE SO THEY CAN REMOVE, RELOCATE, DISCONNECT, CAP OR PLUG THEIR EQUIPMENT IN ORDER TO FACILITATE DEMOLITION. DIAL 811 BEFORE DIGGING OR CALL 800-282-7411.
- 3. THE CONTRACTOR IS RESPONSIBLE FOR THE PROTECTION OF ALL TREES, STRUCTURES, AND UTILITIES NOT MARKED FOR REMOVAL OR DEMOLITION AND SHALL PROMPTLY REPAIR ANY DAMAGE AS DIRECTED BY THE ENGINEER AT NO COST TO THE
- 4. THE CONTRACTOR SHALL REMOVE PAVING MARKED FOR DEMOLITION WHICH INCLUDES ALL ASPHALT, CONCRETE, BASE, AND RETAINING WALLS (INCLUDING THE FOOTERS).
- 5. THE CONTRACTOR SHALL REMOVE TREES MARKED FOR REMOVAL WHICH INCLUDES THE ROOTS ASSOCIATED WITH THE TREE. TREES NOT MARKED FOR REMOVAL SHALL BE PROTECTED IN ACCORDANCE WITH THE FAYETTE COUNTY REGULATIONS.
- 6. THE CONTRACTOR SHALL REMOVE UNSALVAGEABLE MATERIALS AND YARD WASTE FROM THE SITE IMMEDIATELY AND DISPOSE OF IN ACCORDANCE WITH APPLICABLE FEDERAL, STATE, AND LOCAL REGULATIONS
- 7. THE CONTRACTOR SHALL SAW-CUT A SMOOTH STRAIGHT EDGE ON ANY PAVEMENT PROPOSED FOR DEMOLITION PRIOR TO ITS REMOVAL. PRIOR TO CONNECTING PROPOSED PAVEMENT TO EXISTING PAVEMENT, THE CONTRACTOR SHALL ENSURE THAT THE EDGE OF THE EXISTING PAVEMENT IS STRAIGHT AND UNIFORM.
- 8. THE DEMOLITION SHALL BE PHASED TO PROVIDE AT LEAST ONE 12 FOOT LANE OF TRAFFIC AT ALL TIMES.
- 9. CONTRACTOR TO FOLLOW ALL APPLICABLE OSHA STANDARDS FOR ALL EXCAVATIONS.

FAYETTE COUNTY WATER SYSTEM NOTES:

- 1. ALL CONSTRUCTION TO BE IN STRICT ACCORDANCE WITH FAYETTE COUNTY WATER SYSTEM SPECIFICATIONS.
- 2. ALL MATERIALS SHALL CONFORM TO FAYETTE COUNTY DEVELOPMENT SPECIFICATIONS. THE CONTRACTOR SHALL PROVIDE FAYETTE COUNTY WATER SYSTEM SUBMITTALS ON ALL PIPE AND MATERIALS USED FOR APPROVAL. ANY WORK DONE BY THE CONTRACTOR SHALL BE AT HIS OWN RISK UNTIL REVIEW AND APPROVAL OF THESE SUBMITTALS ARE COMPLETE.
- 3. THE CONTRACTOR SHALL NOTIFY THE FAYETTE COUNTY WATER SYSTEM 48 HOURS PRIOR TO CONSTRUCTION TO SCHEDULE A PRE-CONSTRUCTION CONFERENCE.
- 4. THE CONTRACTOR SHALL SCHEDULE AN INSPECTION BY THE FAYETTE COUNTY WATER SYSTEM BEFORE ANY WORK IS HIDDEN FROM VIEW.
- 5. THE CONTRACTOR IS RESPONSIBLE FOR NOTIFYING ALL UTILITIES BEFORE CONSTRUCTION AND VERIFYING THE LOCATION
- 6. IT SHALL BE THE CONTRACTOR'S RESPONSIBILITY TO NOTIFY AND COORDINATE HIS WORK WITH EXISTING UTILITIES WHICH CONFLICT WITH HIS WORK. CONTRACTOR SHALL MAINTAIN SUCH UTILITIES SHOWN OR NOT SHOWN ON THIS PLAN.
- 7. ALL VALVE BOXES ARE TO HAVE COLLARS AND MARKERS AS REQUIRED BY THE FAYETTE COUNTY WATER SYSTEM DEPARTMENT.
- 8. WATER LINES SHALL HAVE A MINIMUM COVER OF 4 FEET FROM FINISHED GRADE
- 9. MINIMUM HORIZONTAL DISTANCE BETWEEN WATER LINES AND SEWER SHALL BE 10 FEET AND VERTICAL DISTANCE MINIMUM OF 2 FEET.
- 10. ALL OTHER UNDERGROUND UTILITIES OR STRUCTURES SHALL BE A MINIMUM HORIZONTAL AND VERTICAL DISTANCE OF 2 FEET FROM WATER LINES.
- 11. WATER LINES SHALL BE LOCATED 7'-0" FROM THE BACK OF THE CURB OR PER AS APPROVED UTILITY PLACEMENT DETAIL.
- 12. ALL WATER SERVICES SHALL BE MARKED WITH A SAWED "W" NOTCH PAINTED BLUE ON THE CURB.
- 13. ALL WATER MAIN CROSSING UNDER PAVEMENT SHALL BE DIP IN STEEL CASING AS PER FAYETTE COUNTY WATER SYSTEM
- 14. ALL VALVES AND FITTINGS ARE TO BE RESTRAINED WITH APPROPRIATE TYPE AND NUMBER OF EBBA IRON OR UNIFLANGE RESTRAINT SYSTEM APPURTENANCES APPROVED BY THE FAYETTE COUNTY WATER SYSTEM PRIOR TO CONSTRUCTION. ANY CONCRETE BLOCKING THAT IS ALLOWED SHALL BE INSTALLED TO UNDISTURBED EARTH.
- 15. ALL SERVICE LINES CROSSING UNDER PAVEMENT OR IN FRONT OF LOTS SHALL BE ENCASED IN 2" CONDUIT MATERIAL APPROVED BY FAYETTE COUNTY WATER SYSTEM.

ESPC NOTES

- 1. AMENDMENTS/REVISIONS TO THE ES&PC PLAN WHICH HAVE A SIGNIFICANT EFFECT ON BMPS WITH A HYDRAULIC COMPONENT MUST BE CERTIFIED BY THE DESIGN PROFESSIONAL.
- 2. WASTE MATERIALS SHALL NOT BE DISCHARGED TO WATERS OF THE STATE, EXCEPT AS AUTHORIZED BY A SECTION 404 PERMIT.
- 3. ALL BUFFERS AND TREE SAVE AREAS SHALL BE CLEARLY IDENTIFIED WITH FLAGGING AND/OR FENCING PRIOR TO
- COMMENCEMENT OF ANY LAND DISTURBANCE.

 4. SEDIMENT STORAGE MAINTENANCE INDICATORS MUST BE INSTALLED IN SEDIMENT STORAGE STRUCTURES, INDICATING THE
- 1/3 FULL VOLUME.

 5. INSPECT AND DOCUMENT THE CONDITION OF RUNOFF CONTROLS EVERY 7 DAYS, OR EVERY 14 DAYS AND WITHIN 24 HOURS
- AFTER EACH RAIN OF 0.5 INCH OR MORE.
- 6. PERMITEE SHALL SUBMIT A SIGNED NOTICE OF TERMINATION (NOT) FORM TO THE GEORGIA DIVISION OF WATER AFTER THE SITE HAS BEEN FINALLY STABILIZED.
- 7. 67 CY/AC SEDIMENT STORAGE SUBSTANTIALLY HANDLED BY SILT FENCE. THE LINEAR NATURE OF THIS PROJECT COUPLED WITH LIMITED WORK AREA (ESPECIALLY ADJACENT TO STATE WATER) DOES NOT PROVIDE OPPORTUNITY FOR INSTALLATION OF PERMANENT BMPS TO PREVENT POLLUTANTS FROM DISCHARGING THE SITE WITHOUT FURTHER ENCROACHMENT INTO ADJACENT PRIVATE PROPERTY. DURING CONSTRUCTION, SILT FENCE WILL BE USED TO PREVENT POLLUTANTS FROM DISCHARGING THE SITE. AFTER CONSTRUCTION IS COMPLETE ALL AREAS WILL BE STABILIZED.
- 8. SOIL STOCKPILES MUST BE LOCATED AWAY FROM STREAMS, PONDS, SWALES AND CATCH BASINS. STOCKPILES MUST BE SEEDED, MULCHED, AND ADEQUATELY CONTAINED THROUGH THE USE OF SILT FENCE.
- 9. SEDIMENT-LADEN WATER ENCOUNTERED DURING TRENCHING, BORING, OR OTHER EXCAVATION ACTIVITIES MUST BE PUMPED TO A SEDIMENT TRAPPING OR FILTERING DEVICE AND CLEANED BEFORE BEING DISCHARGED. DISCHARGES TO STORM DRAINS, DITCHES, OR WATER BODIES MUST BE COVERED UNDER A EPD PERMIT.
- 10. ALL BARE SOIL AREAS NOT SUBJECT TO ACTIVE CLEARING, EXCAVATION, GRADING, OR FILL ACTIVITIES MUST BE STABILIZED WITH TEMPORARY OR PERMANENT SEEDING OR MULCHING WITHIN 14 DAYS.
- 11. GOOD HOUSEKEEPING PRACTICES MUST BE APPLIED TO PREVENT CONTAMINATED RUNOFF OR OTHER IMPACTS FROM PAINT OR CONCRETE WASTES, FUELS AND OILS, TRASH AND LITTER, OR OTHER MATERIALS.
- SILT FENCES, DITCH CHECKS, NON-PERMANET SEDIMENT TRAPS, AND OTHER TEMPORARY CONTROLS MUST BE REMOVED AFTER VEGETATION IN UPGRADIENT AREAS IS ESTABLISHED AND DITCHES ARE STABLE.
 GOOD HOUSEKEEPING MEASURES FOR MATERIALS STORAGE AND HANDLING, VEHICLE FUELING AND MAINTENANCE, SPILL
- RESPONSE AND CLEANUP, AND WASTE MANAGEMENT MUST BE FOLLOWED TO ENSURE THAT RUNOFF FROM THE SITE IS FREE OF CONTAMINANTS.
- 14. ALL BMPS SELECTED SHALL BE INSTALLED, OPERATED, AND MAINTAINED ACCORDING TO GSWCC FIELD MANUAL, GEORGIA DIVISION OF WATER GUIDELINES, MANUFACTURER'S REQUIREMENTS, OR STANDARD INDUSTRY PRACTICE, AS APPROPRIATE.
- 15. APPROVED PLANS AND NPDES DAILY LOG MUST BE ONSITE AT ALL TIMES.

EARTHWORK, GRADING, STABILIZATION, PAVING AND DRAINAGE NOTES

- 1. COMPACT ALL UTILITY TRENCHES WITHIN ROADWAYS TO 98% OF THE MODIFIED PROCTOR MAXIMUM DENSITY (AASHTO T 180) AND TO 95% WITHIN OTHER AREAS.
- 2. ALL ORGANIC SOILS AS DETERMINED WITHIN UTILITY TRENCHES SHALL BE REMOVED AND REPLACED WITH SUITABLE MATERIAL AND COMPACTED TO NO LESS THAN 98% OF THE MODIFIED PROCTOR MAXIMUM DENSITY (AASHTO T 180).
- 3. STABILIZED SUBGRADE TO MEET SPECIFIED REQUIREMENTS.
- 4. ASPHALTIC CONCRETE TO GDOT STANDARD SPECIFICATION (LATEST EDITION) SECTION 916.1 AND FAYETTE COUNTY, WHICHEVER IS GREATER.
- 5. ALL PAVEMENT MARKINGS SHALL BE THERMOPLASTIC.
- 6. ALL CONCRETE FLUMES, WALKS, AND CURBS SHALL BE CONSTRUCTED WITH 3000 PSI CONCRETE
- 7. ALL ON-SITE AREAS DISTURBED BY THE CONSTRUCTION SHALL BE STABILIZED USING MEASURES THAT MATCH THE EXISTING VEGETATIVE CONDITIONS OF THE SITE. CONTRACTOR IS RESPONSIBLE FOR IRRIGATION OF PERMANENT GRASSING.
- 8. THE REINFORCED CONCRETE PIPE SHALL BE CLASS III WITH WALL THICKNESS "B" CONFORMING TO ASTM C 76 OR AWWA 302 -74 AND GASKETS SHALL BE IN ACCORDANCE WITH ASTM C 443 OR ASTM D 412.
- 9. ALL PIPE CALL OUTS ARE MEASURED CENTER LINE TO CENTER LINE FOR MANHOLES AND INLETS AND FROM THE END OF THE PIPE FOR MITERED END SECTIONS.
- 10. ALL DEWATERING COSTS ASSOCIATED WITH THE INSTALLATION AND CONSTRUCTION OF THE UNDERGROUND UTILITIES; STORM WATER PIPES AND MANHOLES; SANITARY SEWER MAINS, FORCE MAINS, MANHOLES, AND LIFT STATIONS; AND STORM WATER MANAGEMENT SYSTEMS SHALL BE INCLUDED AS PART OF THE CONSTRUCTION BID COSTS. THE CONTRACTOR SHALL SUBMIT FOR WATER USE PERMITS IF REQUIRED FOR DEWATERING ACTIVITIES.
- 11. ALL PIPES SHALL HAVE 3 FEET MINIMUM COVER UNLESS OTHERWISE SPECIFIED IN PLANS, CONTRACTOR SHALL TAKE CARE TO PROVIDE PROPER GRADE ELEVATIONS AND ALIGNMENTS.
- 12. THE CONTRACTOR MUST INSTALL AND MAINTAIN GRASS OR SOD ON EXPOSED SLOPES WITHIN 48 HOURS OF COMPLETED FINAL GRADES, AS NOTED ON PLANS, AND AT ANY OTHER TIME AS NECESSARY TO PREVENT EROSION, SEDIMENTATION OR TURBID DISCHARGES TO ANY DOWNSTREAM WATER BODY, WETLAND, OR OFF-SITE PROPERTY. SODDING ON SLOPES 3:1 AND STEEPER SHALL BE STAKED.
- 13. THE CONTRACTOR SHALL TAKE ALL MEASURES NECESSARY TO CONTROL TURBIDITY AND SEDIMENT INCLUDING, BUT NOT LIMITED TO, THE INSTALLATION OF TURBIDITY BARRIERS AND SILT FENCES AT ALL LOCATIONS WHERE THE POSSIBILITY OF TRANSFERRING SUSPENDED SOLIDS INTO THE RECEIVING WATER BODY EXISTS DUE TO THE PROPOSED WORK. TURBIDITY AND SEDIMENT BARRIERS MUST BE MAINTAINED AT ALL LOCATIONS UNTIL CONSTRUCTION IS COMPLETED AND DISTURBED SOIL AREAS ARE STABILIZED. THE CONTRACTOR SHALL ALSO BE RESPONSIBLE FOR REMOVING THE BARRIERS.
- 14. EXISTING RUNOFF CURVE NUMBER FOR THE PROJECT: 61. PROPOSED RUNOFF CURVE NUMBER FOR THE PROJECT: 61.
- 15. ALL CONCRETE STRUCTURES SHOWN ARE PRE-CAST FROM AN APPROVED VENDOR. CAST-IN-PLACE METHODS MAY BE USED FOR STRUCTURE COMPONENTS WHERE APPLICABLE FOR APPROVAL.

OTHER UTILITY INFORMATION

- THE CONTRACTOR SHALL NOTIFY UTILITY COMPANIES WHICH MAY HAVE THEIR UTILITIES WITHIN THE CONSTRUCTION AREAS TO LOCATE THEIR FACILITIES IN THE FIELD FORTY-EIGHT (48) HOURS PRIOR TO BEGINNING CONSTRUCTION. DIAL 811 BEFORE DIGGING OR CALL 800-282-7411.
- 2. DUCTILE IRON PIPE SHALL BE ENCASED IN POLYETHYLENE TWENTY-FIVE (25) FEET ON EACH SIDE OF ANY PERPENDICULAR CROSSING OF METALLIC GAS MAINS OR ANY OTHER CATHODICALLY PROTECTED PIPELINE AND FOR LOCATIONS PARALLEL TO AND WITHIN TEN FEET OF METALLIC GAS MAINS OR OTHER CATHODICALLY PROTECTED PIPE AND THROUGH THE AREA OF INFLUENCE OF CATHODIC PROTECTION ANODE BED.

SPILL CONTROL NOTES:

- 1. IN ADDITION TO THE GOOD HOUSEKEEPING AND MATERIAL MANAGEMENT PRACTICES DISCUSSED IN THE PREVIOUS NOTES OF THIS PLAN, THE FOLLOWING PRACTICES WILL BE FOLLOWED FOR SPILL PREVENTION AND CLEANUP:
- a. MANUFACTURERS' RECOMMENDED METHODS FOR SPILL CLEANUP WILL BE CLEARLY POSTED AND SITE PERSONNEL WILL BE MADE AWARE OF THE PROCEDURES AND THE LOCATION OF THE INFORMATION AND CLEANUP SUPPLIES.
- b. ALL SPILLS WILL BE CLEANED UP IMMEDIATELY AFTER DISCOVERY.
- c. SPILLS OF TOXIC OR HAZARDOUS MATERIAL WILL BE REPORTED TO THE APPROPRIATE STATE OR LOCAL GOVERNMENT AGENCY, REGARDLESS OF SIZE.
- d. THE SPILL PREVENTION PLAN WILL BE ADJUSTED TO INCLUDE MEASURES TO PREVENT THIS TYPE OF SPILL FROM REOCCURRING AND HOW TO CLEAN UP THE SPILL IF THERE IS ANOTHER ONE. A DESCRIPTION OF THE SPILL, WHAT CAUSED IT, AND THE CLEANUP MEASURES WILL ALSO BE INCLUDED.
- e. THE SITE SUPERINTENDENT RESPONSIBLE FOR THE DAY-TO-DAY SITE OPERATIONS WILL BE THE SPILL PREVENTION AND CLEANUP COORDINATOR.
- 2. PETROLEUM BASED PRODUCTS CONTAINERS FOR PRODUCTS SUCH AS FUELS, LUBRICANTS, AND TARS WILL BE INSPECTED DAILY FOR LEAKS AND SPILLS. THIS INCLUDES ON-SITE VEHICLE AND MACHINERY DAILY INSPECTIONS AND REGULAR PREVENTATIVE MAINTENANCE OF SUCH EQUIPMENT. EQUIPMENT MAINTENANCE AREAS WILL BE LOCATED AWAY FROM STATE WATERS, NATURAL DRAINS AND STORM WATER DRAINAGE INLETS. IN ADDITION, TEMPORARY FUELING TANKS SHALL HAVE A SECONDARY CONTAINMENT LINER TO PREVENT/MINIMIZE SITE CONTAMINATION. DISCHARGE OF OILS, FUELS AND LUBRICANTS IS PROHIBITED. PROPER DISPOSAL METHODS WILL INCLUDE IN A SUITABLE CONTAINER AND DISPOSAL AS REQUIRED BY LOCAL AND STATE REGULATIONS.

TRAFFIC CONTROL NOTES

- 1. THE CONTRACTOR SHALL SUBMIT A TEMPORARY TRAFFIC CONTROL PLAN TO THE COUNTY FOR APPROVAL PRIOR TO
- COMMENCEMENT OF CONSTRUCTION ACTIVITIES.
- ALL REQUIRED TRAFFIC SIGNAGE MUST MEET MUTCD STANDARDS.
 ALL REQUIRED TRAFFIC STRIPING MUST MEET MUTCD AND GDOT PLAN SPECIFICATIONS AND MUST BE
- THERMO-PLASTIC.

 4. ALL STRIPING LAYOUTS MUST BE APPROVED BY THE COUNTY TRAFFIC ENGINEER PRIOR TO FINAL APPLICATION.
- 5. CONTRACTOR TO COORDINATE LANE CLOSURES WITH FAYETTE COUNTY AND ENGINEER. PROVIDE AT LEAST ONE 12
- FOOT LANE FOR TRAFFIC AT ALL TIMES.

 6. CHANGEABLE MESSAGE SIGNS, INFORMING MOTORISTS OF THE PROJECT START DATE SHALL BE INSTALLED A MINIMUM OF TWO (2) WEEKS PRIOR TO WORK COMMENCING. THESE SIGNS SHALL BE INSTALLED AT OR AS NEAR AS POSSIBLE TO THE PROJECT LIMITS.





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Georgia 30092
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OLILIA IN ORWANION

FAYETTE COUNTY

140 STONEWALL AVE W, STE 203
FAYETTEVILLE, GA. 30214

PROJECT NAME

CROSS CREEK
TRAIL
CULVERT
REPLACEMENT

FAYETTE COUNTY, GA

DRAWING ISSUE

Z

DESIGNED BY: MDW/MIA
DRAWN BY: MDW
CHECKED BY: COA
SUBMITTED BY: TT

SHEET TITLE

1210496

DATE: NOVEMBER 24, 2025

PROJECT#


CIVIL GENERAL NOTES

SHEET NUMBER

C-002

SHEET 3 OF 20

ORIGINAL SHEET SIZE: 22" X 34"

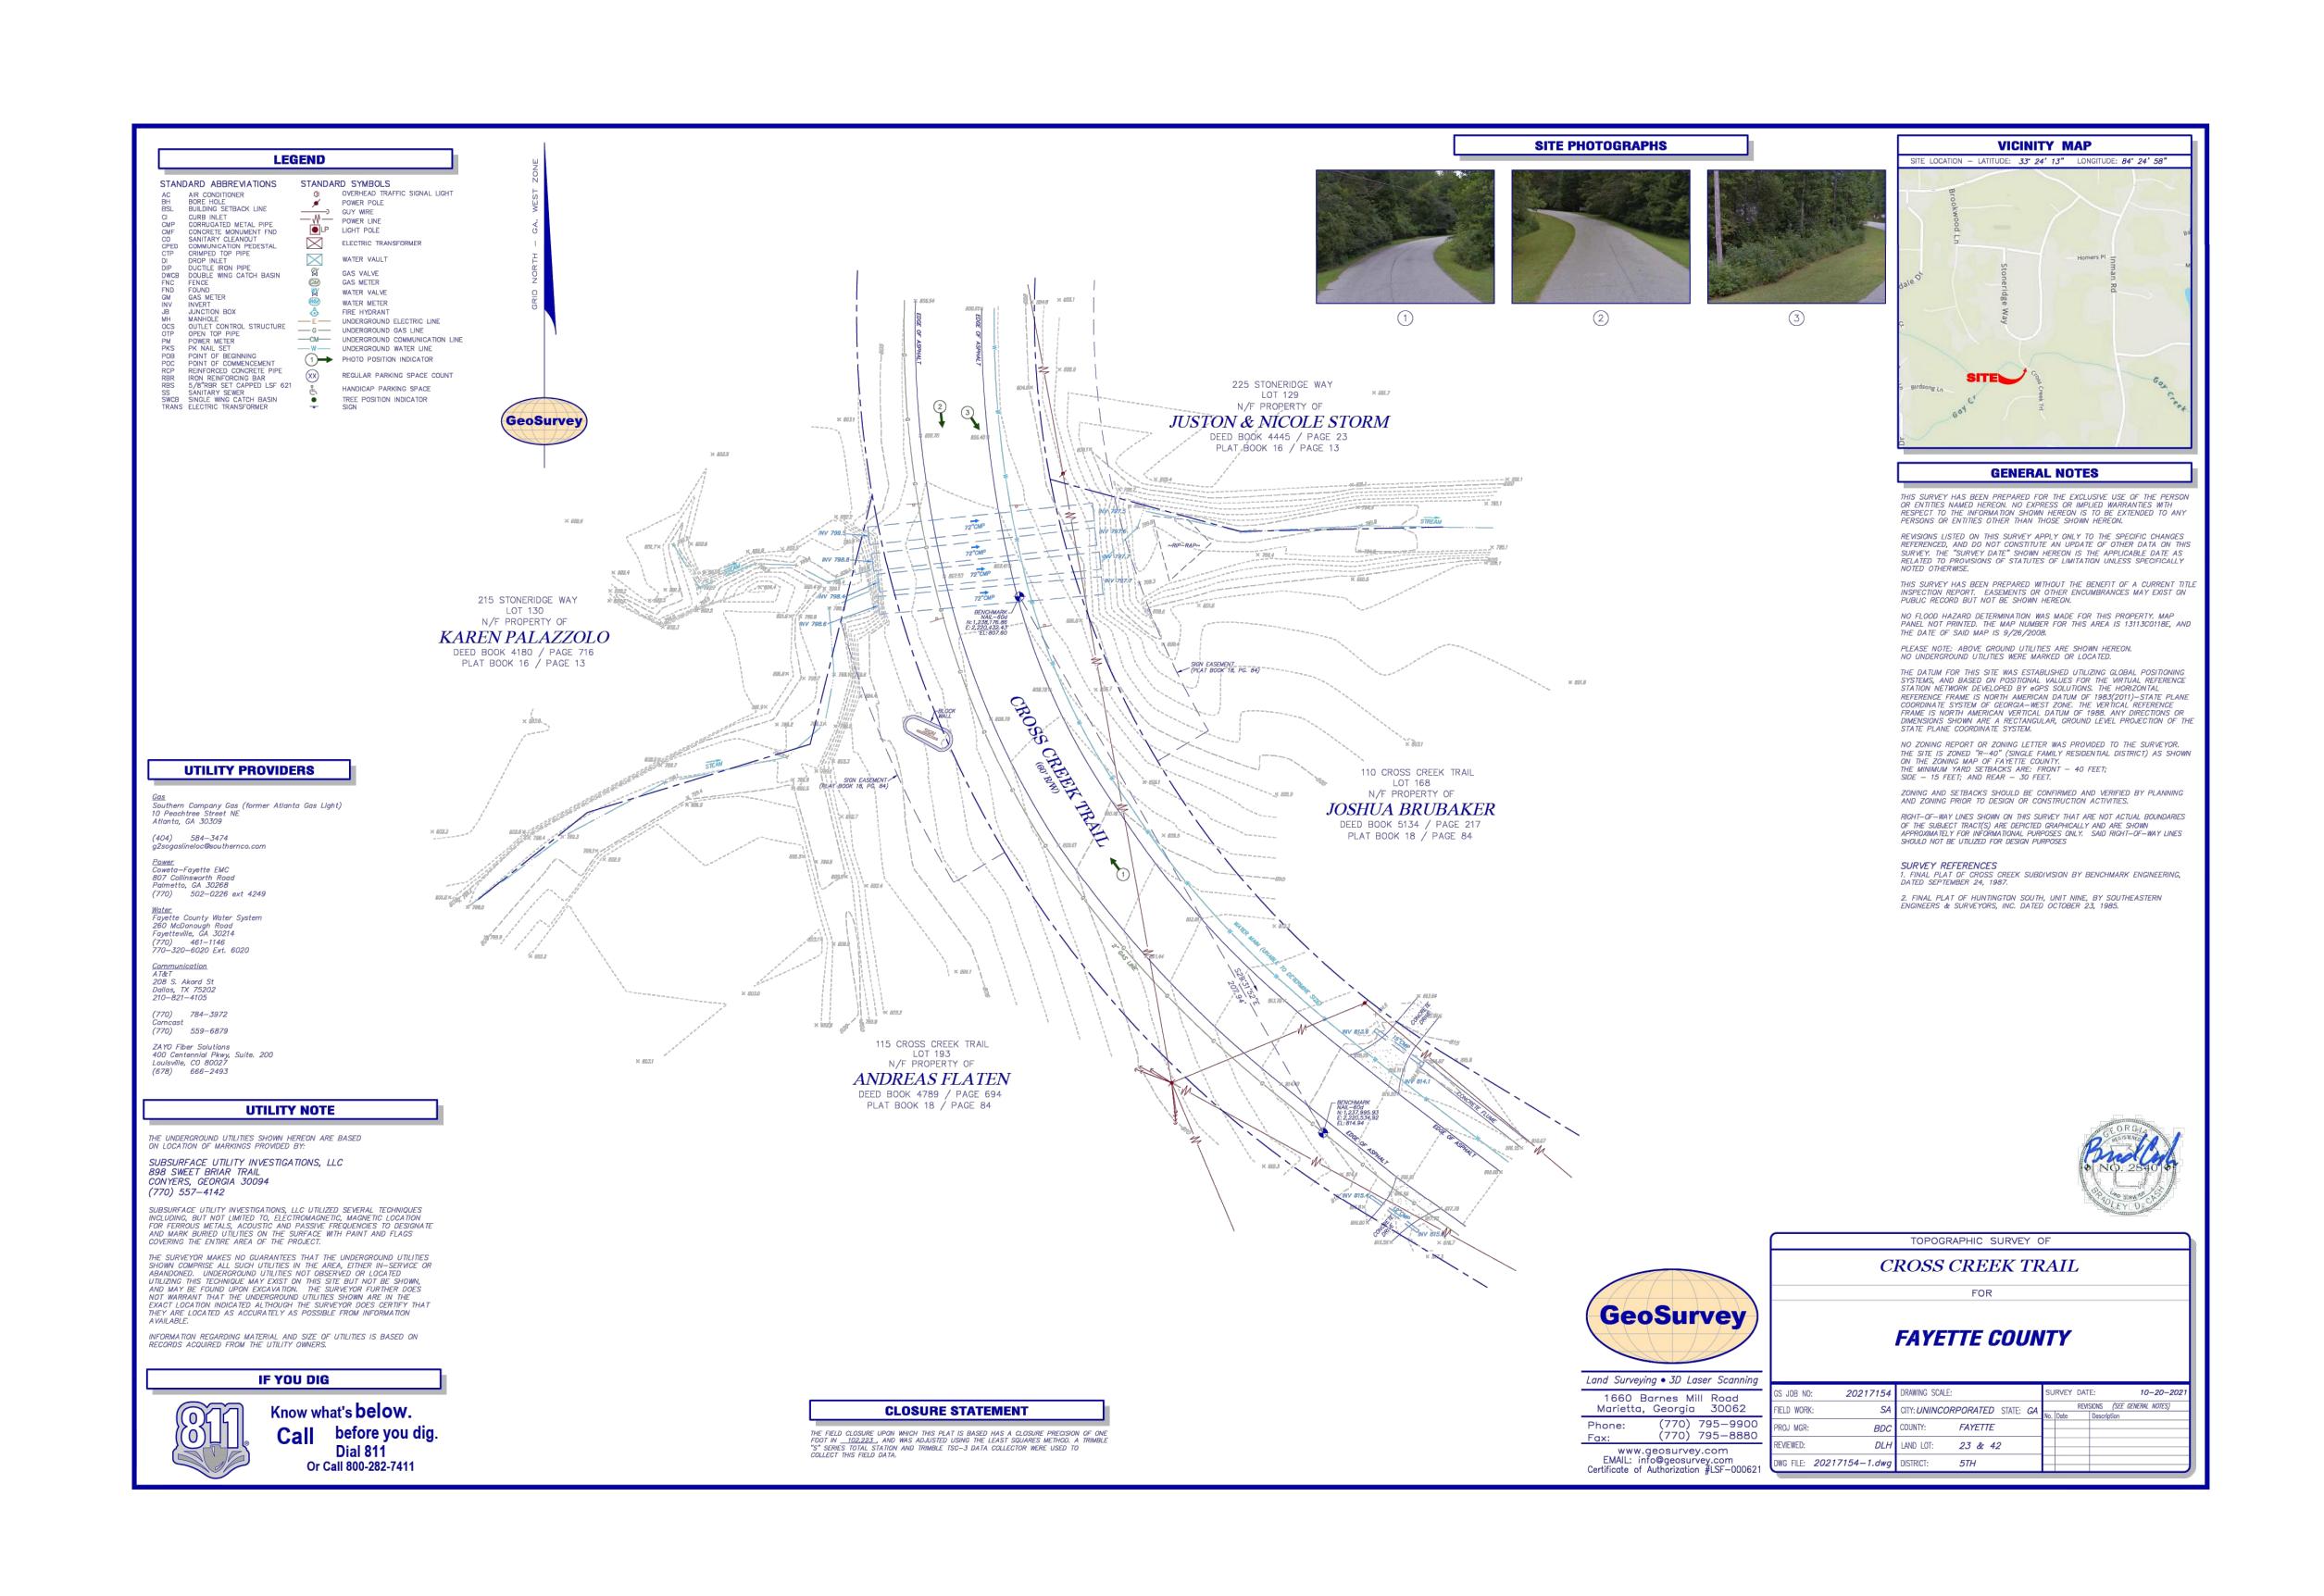

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Suite 500
Peachtree Corners
Georgia 30092
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CLIENT INFORMATION

FAYETTE COUNTY

140 STONEWALL AVE W, STE 203 FAYETTEVILLE, GA. 30214

PROJECT NAME

CROSS CREEK TRAIL CULVERT REPLACEMENT

FAYETTE COUNTY, GA

DRAWING ISSUE

NOI

DESCRIE

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DESIGNED BY: MDW/MIA

DRAWN BY: MDW

CHECKED BY: COA

SUBMITTED BY: TT

DATE: NOVEMBER 24, 2025

SHEET TITLE

1210496

TOPOGRAPHIC SURVEY

PROJECT#

SHEET NUMBER

V-001


ORIGINAL SHEET SIZE:

ORIGINAL SHEET SIZE: 22" X 34"

SHEET 4 OF 20

В

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CLIENT INFORMATION

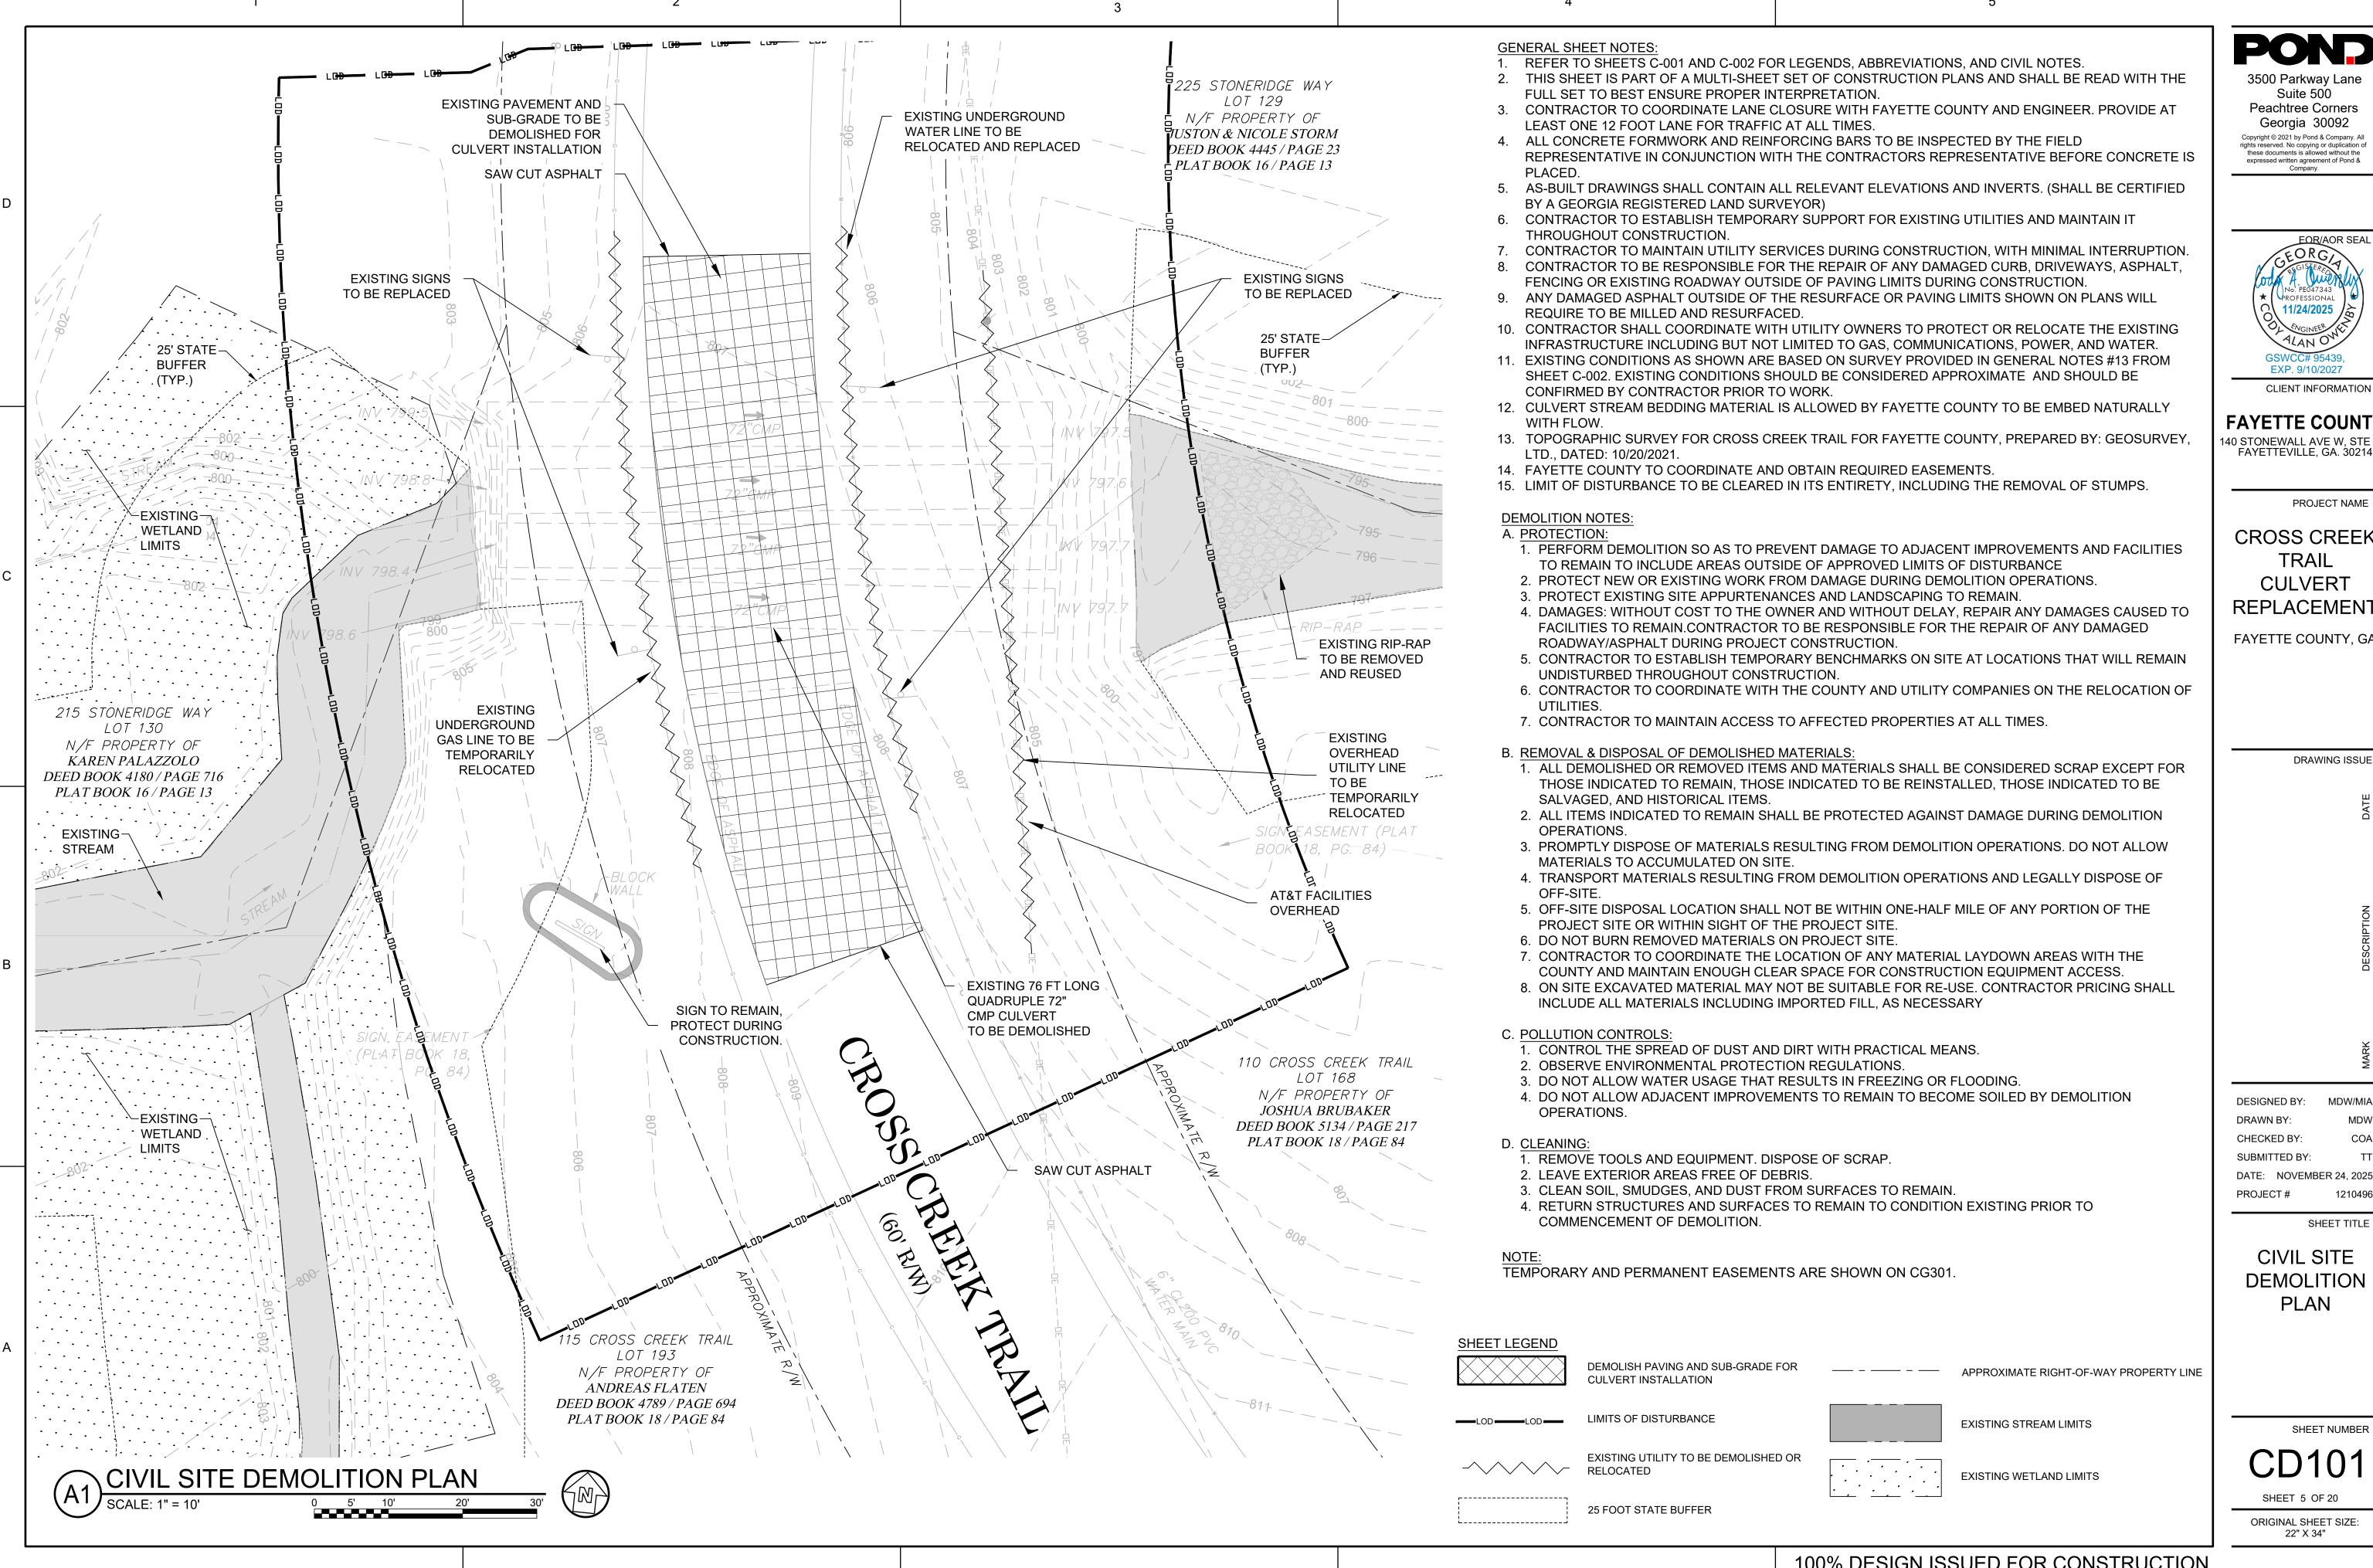FAYETTE COUNTY

140 STONEWALL AVE W. STE 203 FAYETTEVILLE, GA. 30214

PROJECT NAME

CROSS CREEK TRAIL CULVERT REPLACEMENT

FAYETTE COUNTY, GA

DRAWING ISSUE

MDW/MIA DESIGNED BY: DRAWN BY CHECKED BY: SUBMITTED BY:

SHEET TITLE


CIVIL SITE **DEMOLITION** PLAN

SHEET NUMBER

CD101

ORIGINAL SHEET SIZE: 22" X 34"

SHEET 5 OF 20

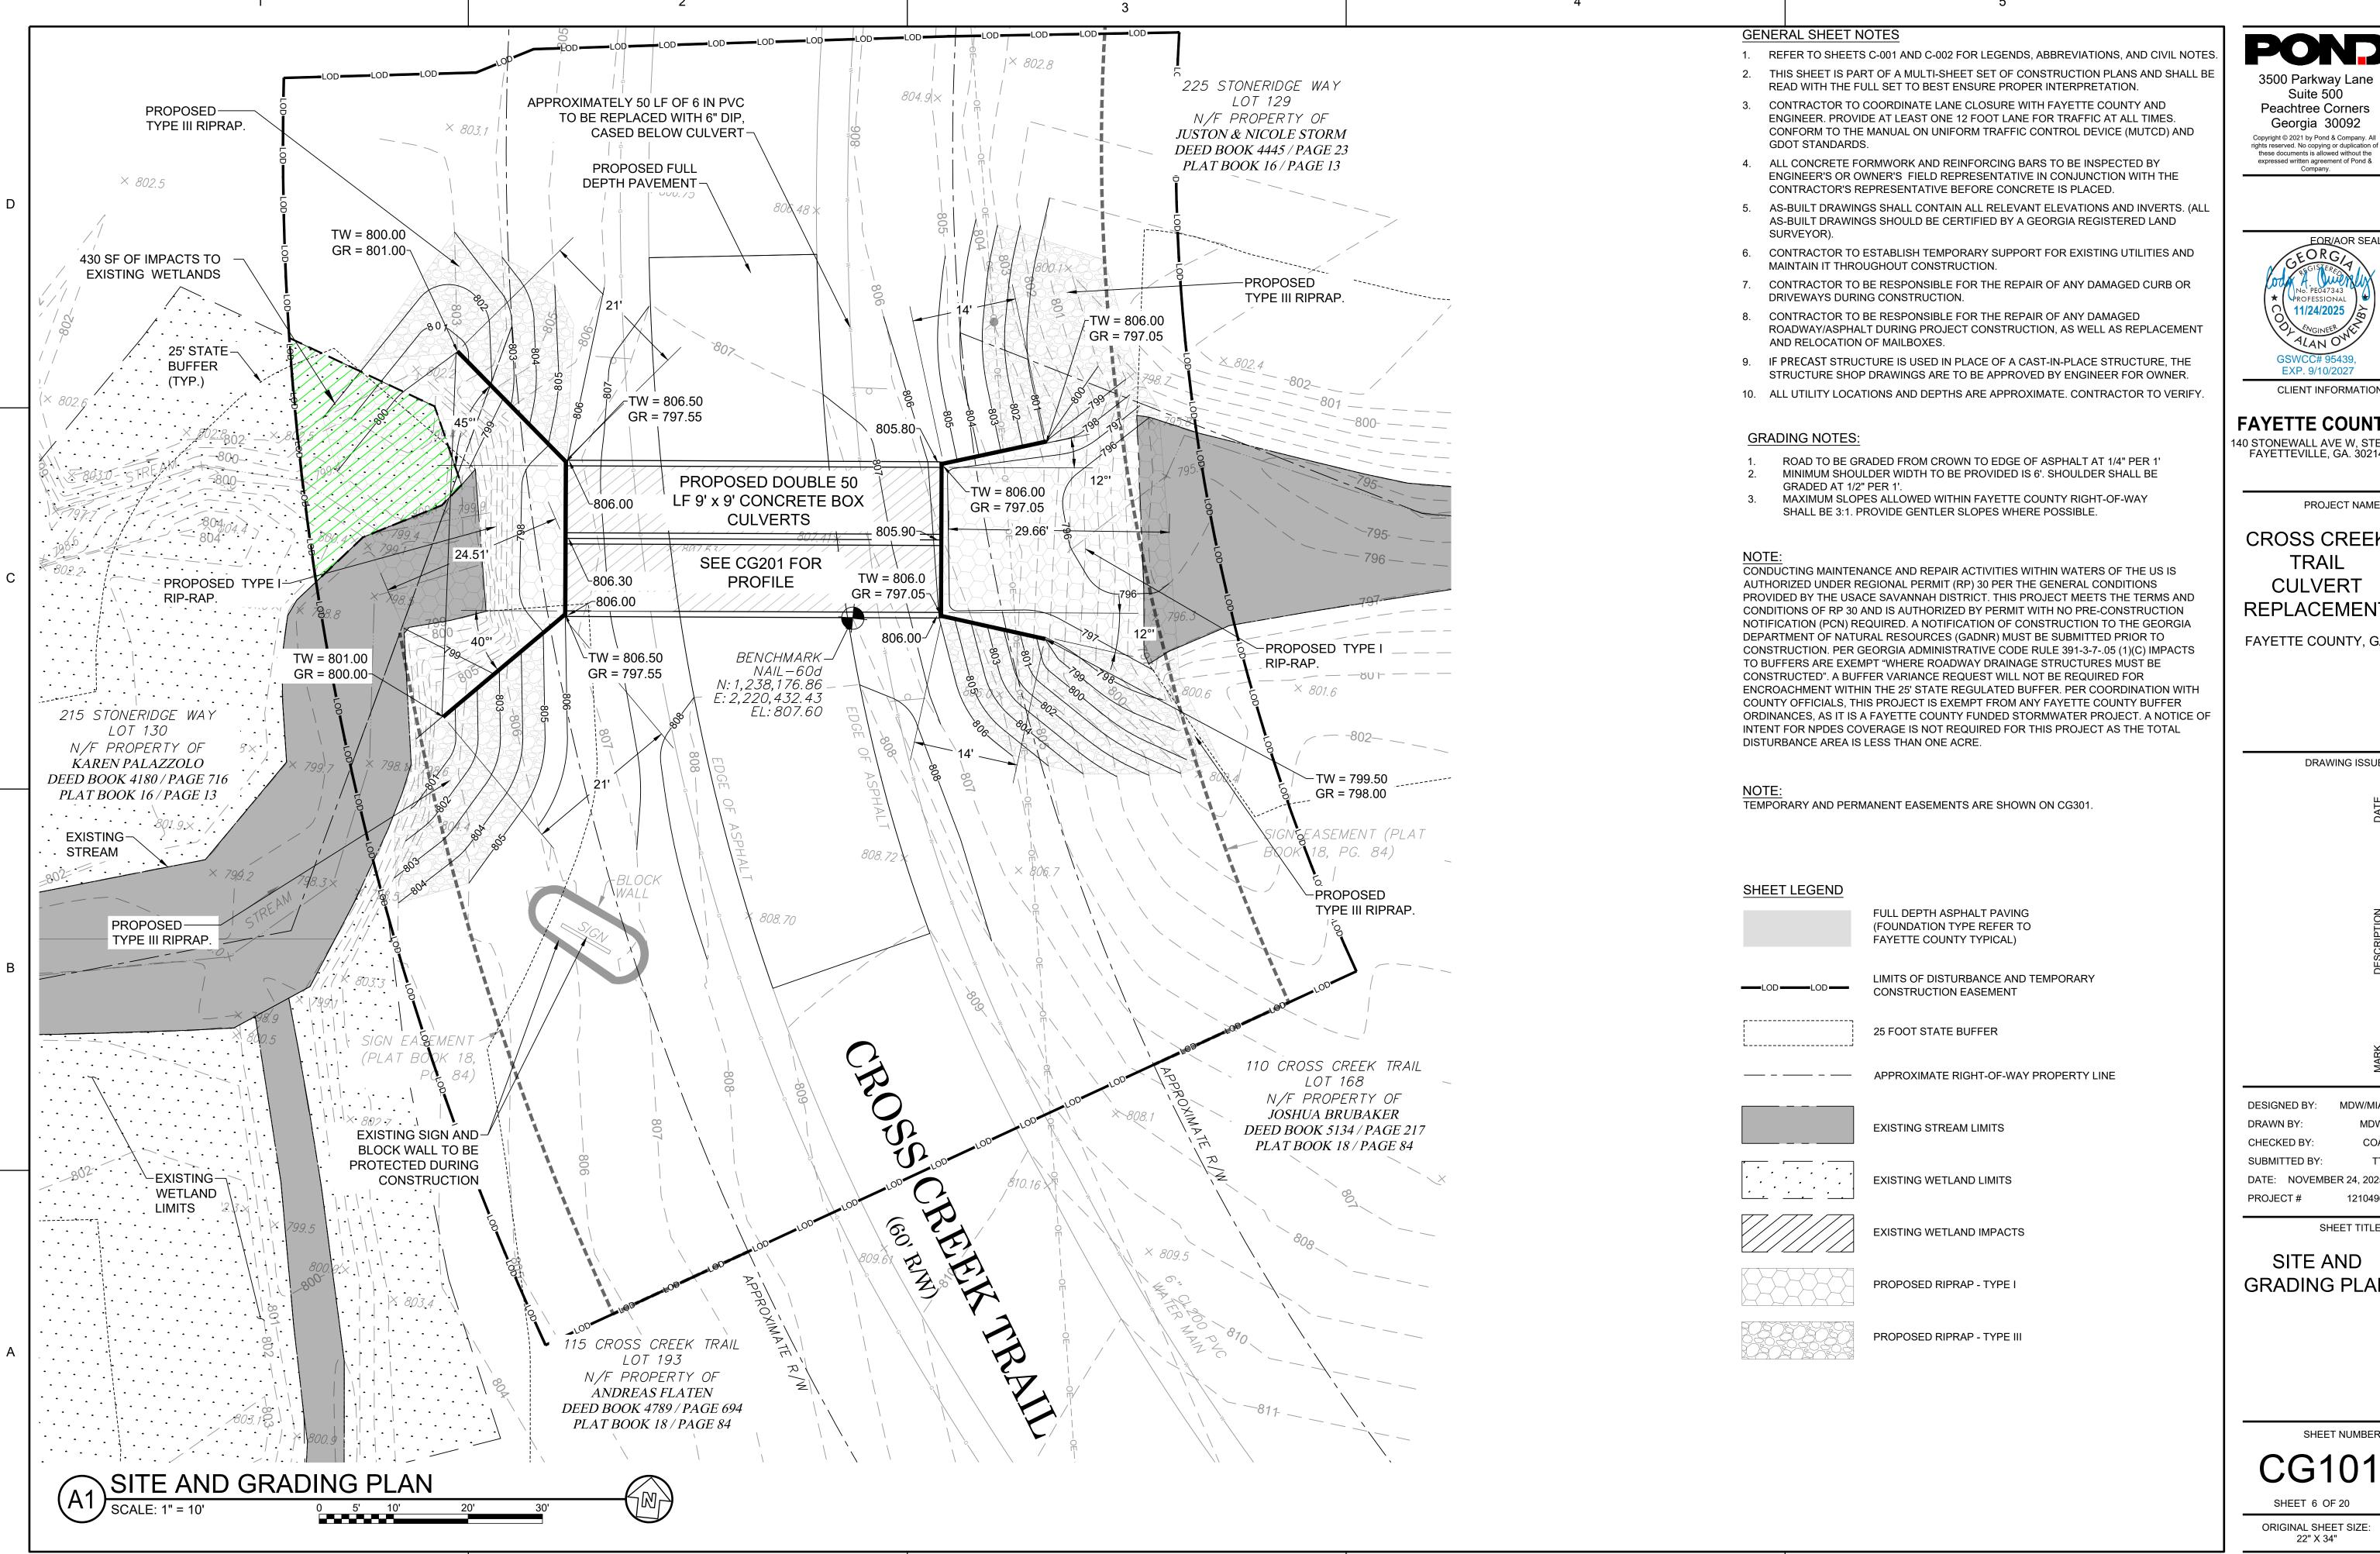

3500 Parkway Lane Suite 500 Peachtree Corners Georgia 30092

EXP. 9/10/2027

CLIENT INFORMATION

FAYETTE COUNTY

140 STONEWALL AVE W, STE 203 FAYETTEVILLE, GA. 30214

PROJECT NAME

CROSS CREEK TRAIL CULVERT REPLACEMENT

FAYETTE COUNTY, GA

DRAWING ISSUE

DESIGNED BY: CHECKED BY: SUBMITTED BY: DATE: NOVEMBER 24, 2025

SHEET TITLE

SITE AND **GRADING PLAN**

SHEET NUMBER


CG101

SHEET 6 OF 20

ORIGINAL SHEET SIZE:

		FLOW SUMM	IARY TABLE		
STORM FREQUENCY	FLOW (CFS)	ENERGY GRADE LINE (FT)	HEADWATER ELEVATION (FT)	OUTLET VELOCITY (FPS)	DOWNSTRE/ VELOCITY (FI
10-YEAR	686.00	804.14	804.03	2.4	7.7
25-YEAR	891.00	805.31	805.24	2.8	8.7
100-YEAR	1204.00	806.63	806.58	3.2	8.4
_		_	_	_	•

DRAINAGE AREA = 1319 ACRES AVERAGE STREAM SLOPE = 1.0%

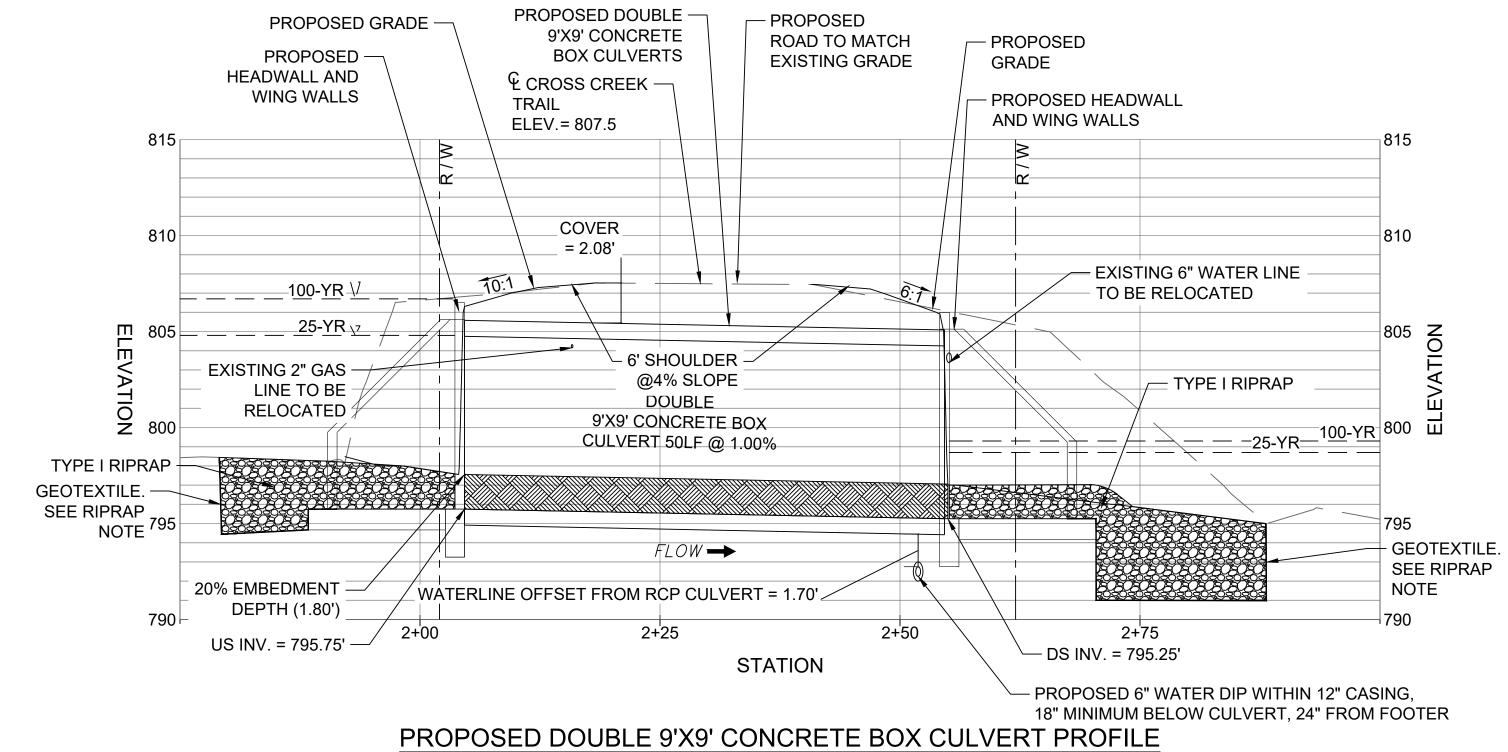

HORIZ. SCALE 1" = 10'

VERT. SCALE 1" = 5'

 GEOTEXTILE SHALL BE PLACED IMMEDIATELY ADJACENT TO THE

 GEOTEXTILE SHALL BE USED AS A SEPARATOR BETWEEN THE GRADED STONE, THE SOIL BASE, AND RGWE ABUTMENTS.

ACCORDANCE WITH AASHTO M288-06 SECTION 8, GEOTEXTILE PROPERTY REQUIREMENTS.

SHEET NUMBER

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EXP. 9/10/2027

FAYETTE COUNTY

140 STONEWALL AVE W, STE 203 FAYETTEVILLE, GA. 30214

CROSS CREEK

TRAIL

CULVERT

REPLACEMENT

FAYETTE COUNTY, GA

PROJECT NAME

DRAWING ISSUE

MDW/MIA

1210496

SHEET TITLE

DESIGNED BY:

CHECKED BY:

PROJECT#

SUBMITTED BY:

DATE: NOVEMBER 24, 2025

CULVERT

PROFILE

DRAWN BY:

CLIENT INFORMATION

CG201

ORIGINAL SHEET SIZE:

22" X 34"

SHEET 7 OF 20

• GEOTEXTILE SHALL BE SPECIFIED IN


SUBGRADE WITHOUT ANY VOIDS.

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FAYETTE COUNTY

140 STONEWALL AVE W, STE 203 FAYETTEVILLE, GA. 30214

PROJECT NAME

CROSS CREEK TRAIL CULVERT REPLACEMENT

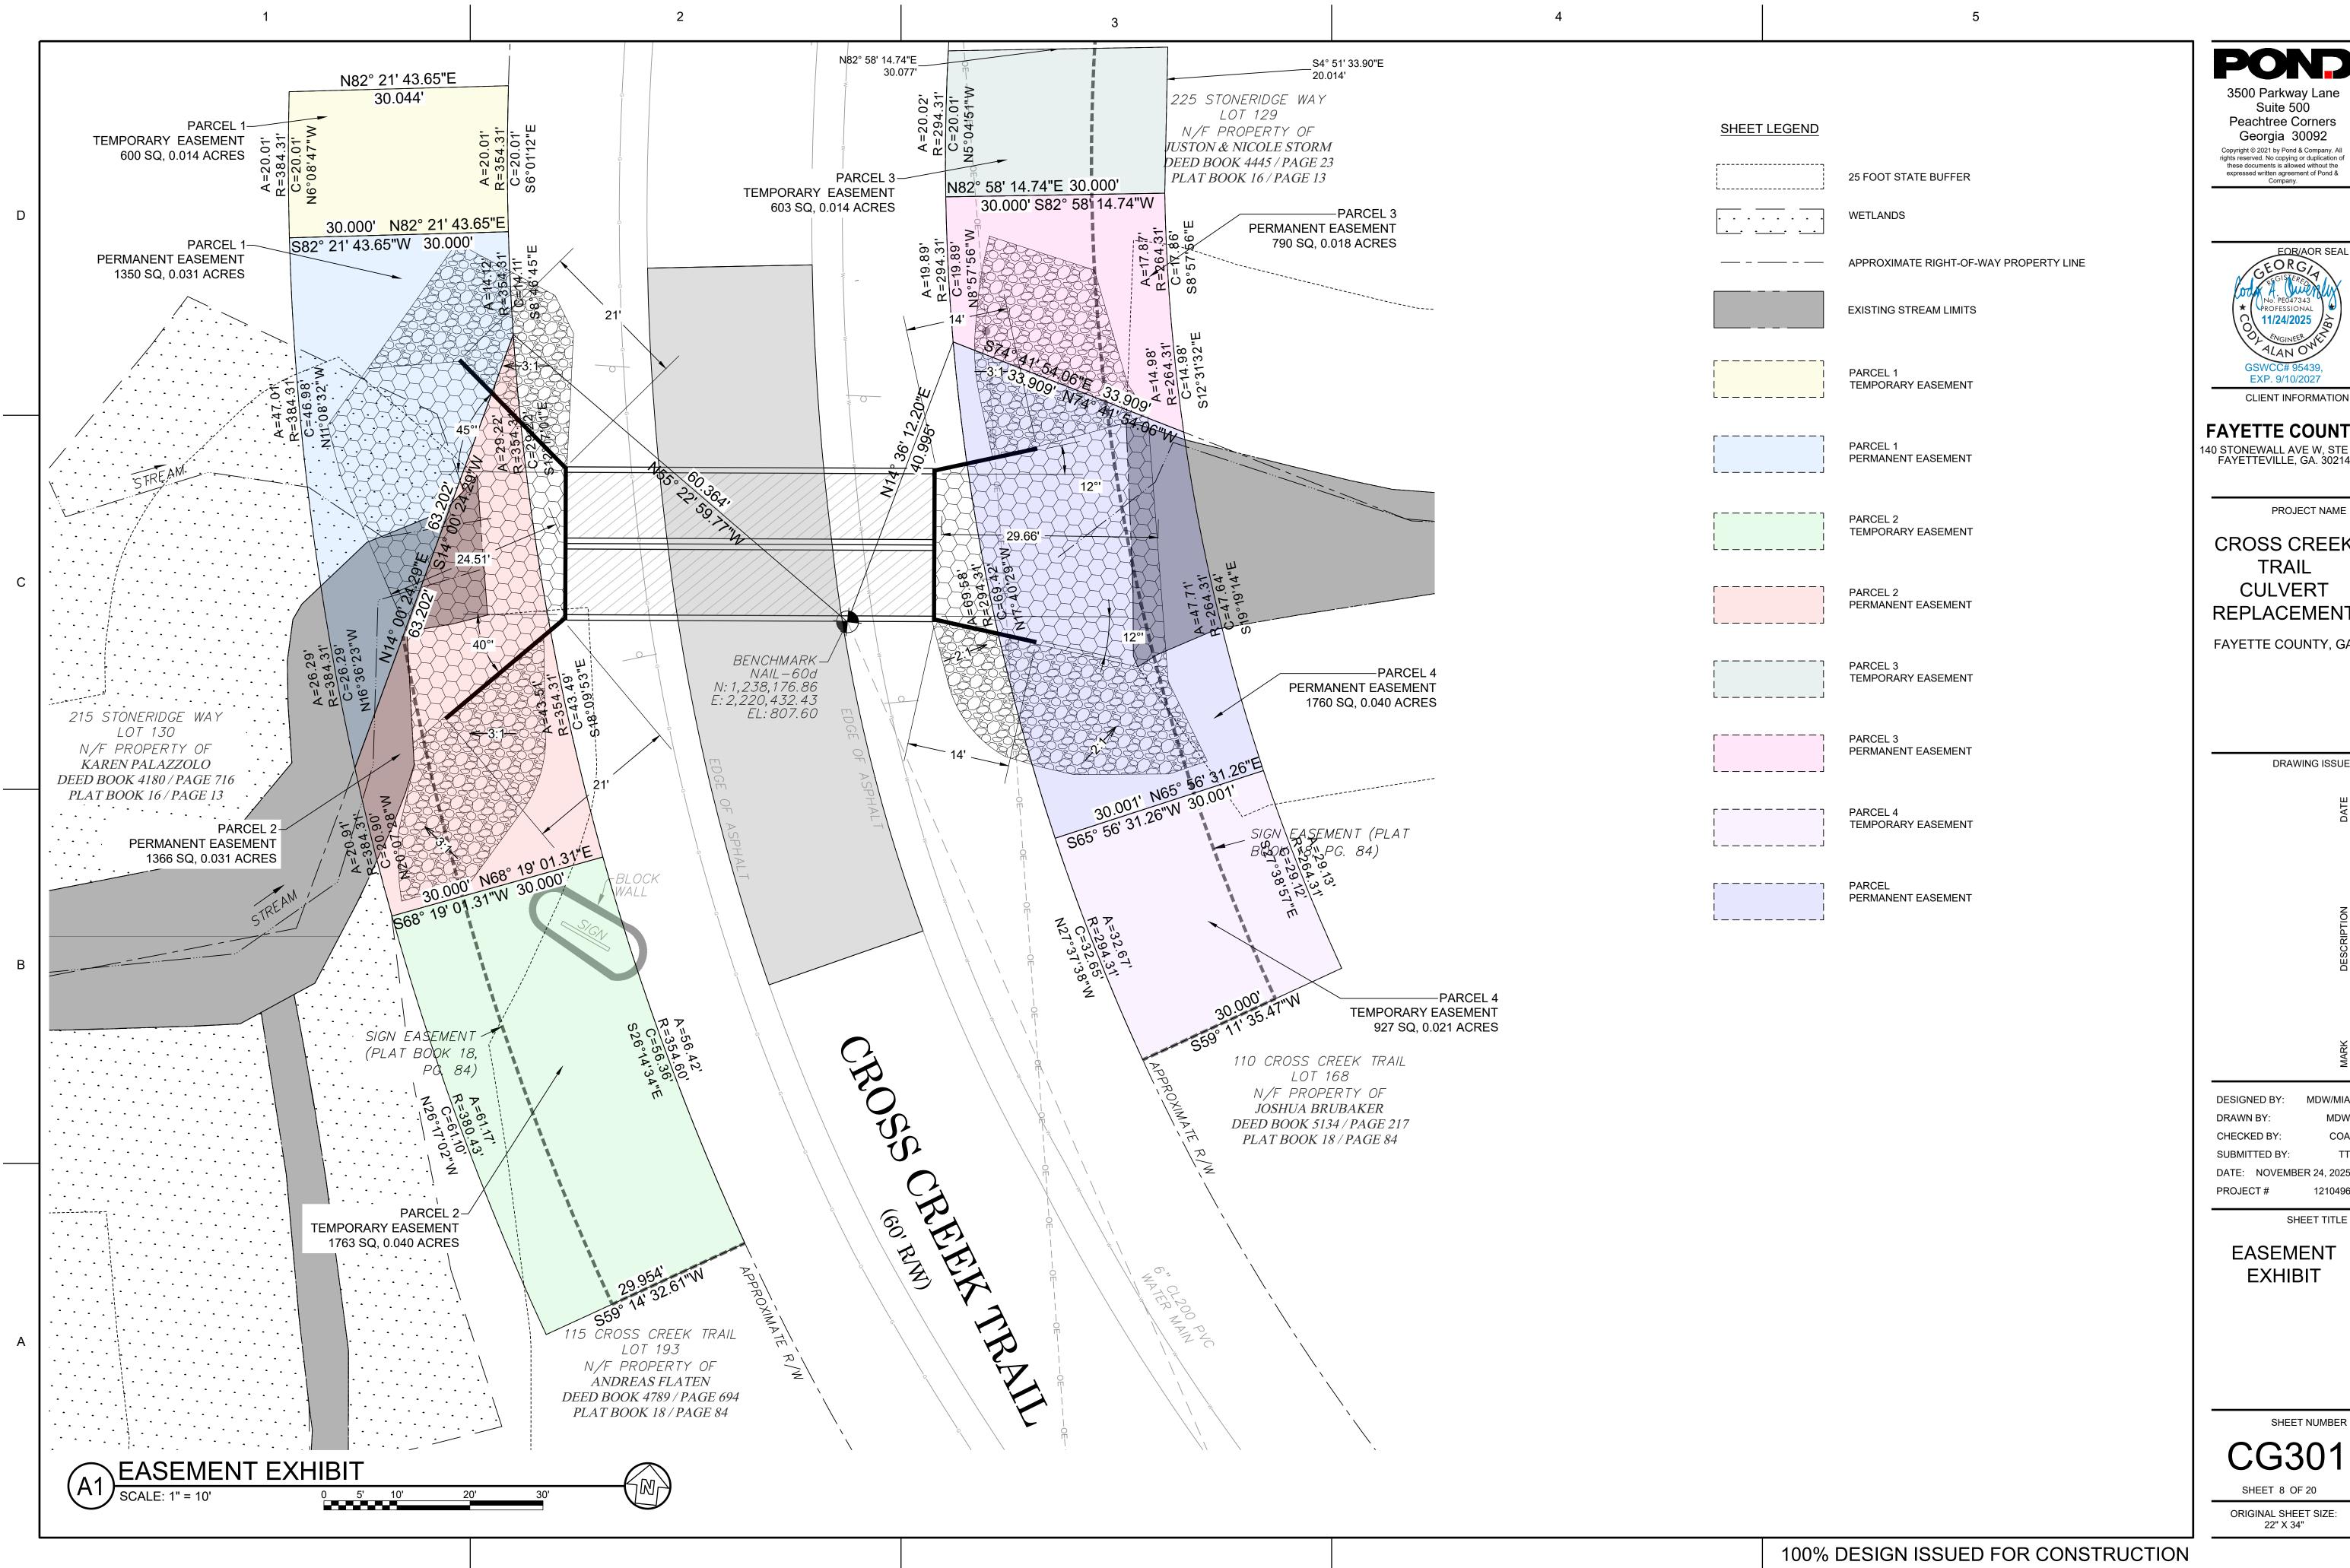FAYETTE COUNTY, GA

DRAWING ISSUE

DESIGNED BY: DRAWN BY: CHECKED BY: SUBMITTED BY: DATE: NOVEMBER 24, 2025

SHEET TITLE

EASEMENT EXHIBIT

SHEET NUMBER

CG301

ORIGINAL SHEET SIZE:

AMENDMENTS/REVISIONS TO THE ES&PC PLAN WHICH HAVE A SIGNIFICANT EFFECT ON BMPS WITH A HYDRAULIC COMPONENT MUST BE CERTIFIED BY THE DESIGN PROFESSIONAL.

WASTE MATERIALS SHALL NOT BE DISCHARGED TO WATERS OF THE STATE, EXCEPT AS AUTHORIZED BY A SECTION

THE ESCAPE OF SEDIMENT FROM THE SITE SHALL BE PREVENTED BY THE INSTALLATION OF EROSION AND SEDIMENT

CONTROL MEASURES AND PRACTICES PRIOR TO, OR CONCURRENT WITH, LAND DISTURBING ACTIVITIES.

EROSION CONTROL MEASURES WILL BE MAINTAINED AT ALL TIMES. IF FULL IMPLEMENTATION OF THE APPROVED PLAN DOES NOT PROVIDE FOR EFFECTIVE EROSION CONTROL, ADDITIONAL EROSION AND SEDIMENT CONTROL MEASURES SHALL BE IMPLEMENTED TO CONTROL OR TREAT THE SEDIMENT SOURCE

ANY DISTURBED AREA LEFT EXPOSED FOR A PERIOD GREATER THAN 14 DAYS SHALL BE STABILIZED WITH MULCH OR **TEMPORARY SEEDING.**

ALL BUFFERS AND TREE SAVE AREAS SHALL BE CLEARLY IDENTIFIED WITH FLAGGING AND/OR FENCING PRIOR TO COMMENCEMENT OF ANY LAND DISTURBANCE.

SEDIMENT STORAGE MAINTENANCE INDICATORS MUST BE INSTALLED IN SEDIMENT STORAGE STRUCTURES, INDICATING THE 1/3 FULL VOLUME.

DESIGN PROFESSIONAL CERTIFICATION:

I CERTIFY UNDER PENALTY OF LAW THAT THIS PLAN WAS PREPARED AFTER A SITE VISIT TO THE LOCATIONS DESCRIBED HEREIN BY MYSELF OR MY AUTHORIZED AGENT, UNDER MY DIRECT SUPERVISION.

GSWCC LEVEL II CERTIFICATION # 0000095439

11/24/2025

EROSION, SEDIMENTATION, AND POLLUTION CONTROL PLAN GENERAL NOTES

(IN CONFORMANCE WITH STATE OF GEORGIA GENERAL NPDES PERMIT NO. GAR 100001.)

Α

EXPIRES: 09/10/2027

FAYETTE COUNTY ENVIRONMENTAL MANAGEMENT PRIMARY PHIL MALLON

PERMITEE: 140 STONEWALL AVE. W., SUITE 203, FAYETTEVILLE, GA. 30214

PHONE (770) 305-5410

PUBLICWORKS@FAYETTECOUNTYGA.GOV

3500 PARKWAY LANE, SUITE 500 PEACHTREE CORNERS, GEORGIA 30092

PHONE: (678) 336-7740

FAX: (678) 336-7744

GA. P.E. # 27428, E&S LEVEL II CERTIFICATION # 0000011643

CONTRACTOR: TO BE DETERMINED

24-HOUR EROSION AND SEDIMENT CONTROL CONTACT: PHIL MALLON -770-313-9855

TOTAL SITE AREA: 0.42 AC DISTURBED AREA: 0.42 AC

EXISTING LAND USE: THE EXISTING LAND USE CONSISTS OF QUADRUPLE 72-INCH CMP CULVERTS AND A

PROPOSED LAND USE: THE PROJECT CONSISTS OF REMOVING THE EXISTING DETERIORATED QUADRUPLE 72-INCH DIAMETER CMP CULVERTS. EACH CULVERT HAS A


> LENGTH OF 76-FT. THE CULVERTS ARE TO BE REPLACED WITH A DOUBLE 9' X 9' CONCRETE BOX CULVERT.

GPS COORDINATES OF SITE: 33°24'13.33"N, 84°24'58.43"W

NAME OF RECEIVING WATERS: GAY CREEK

AREA OF ON-SITE WETLANDS: .01 AC

National Flood Hazard Layer FIRMette

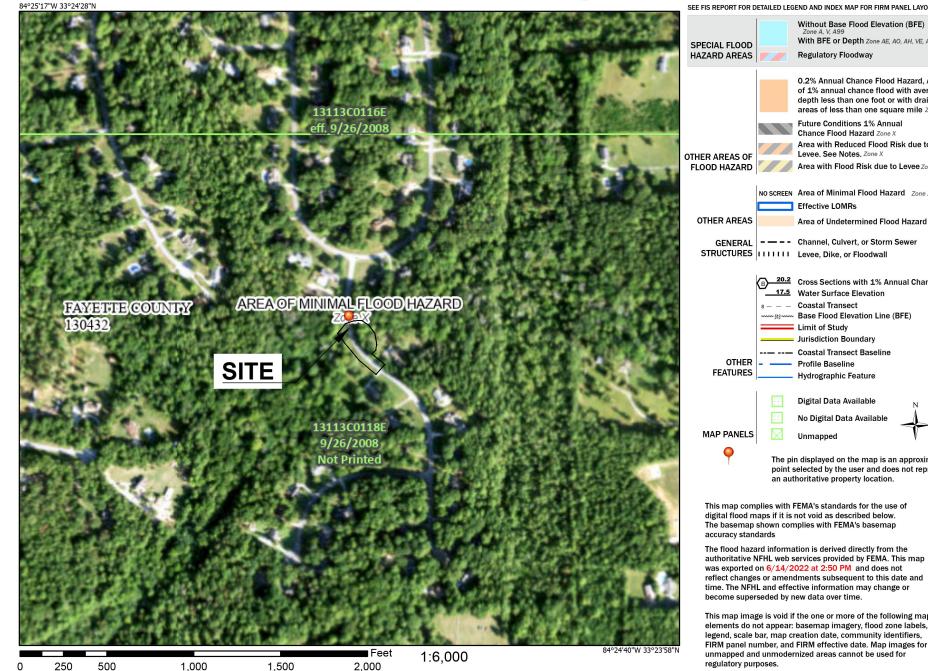

Area with Reduced Flood Risk due to Levee. See Notes. Zone X LOOD HAZARD Area with Flood Risk due to Levee Zone D Effective LOMRs Area of Undetermined Flood Hazard Zone I GENERAL - - - Channel, Culvert, or Storm Sewe STRUCTURES IIIIIII Levee Dike or Floodwall R 20.2 Cross Sections with 1% Annual Chance 17.5 Water Surface Elevation 8 - - - Coastal Transect --- Base Flood Elevation Line (BFE) Limit of Study Jurisdiction Boundary -- -- Coastal Transect Baseline OTHER - Profile Baseline No Digital Data Available MAP PANELS The pin displayed on the map is an approximate point selected by the user and does not represen an authoritative property location This map complies with FEMA's standards for the use of digital flood maps if it is not void as described below.
The basemap shown complies with FEMA's basemap

With BFE or Depth Zone AE, AO, AH, VE, AR

of 1% annual chance flood with average

areas of less than one square mile Zone X

Future Conditions 1% Annual Chance Flood Hazard Zone X

FEMA

Legend

become superseded by new data over time This map image is void if the one or more of the following map elements do not appear: basemap imagery, flood zone labels egend, scale bar, map creation date, community identifiers, FIRM panel number, and FIRM effective date. Map images for unmapped and unmodernized areas cannot be used for Basemap: USGS National Map: Orthoimagery: Data refreshed October, 2020

SOILS LEGEND

Natural Resources

AmB Appling sandy loam, 2 to 6 percent slopes Applying sandy loam, 6 to 10 percent slopes Cecil sandy loam, 2 to 6 percent slopes Cecil sandy clay loam, 6 to 10 percent slopes, eroded Davidson loam, 2 to 6 percent slopes

SYMBOL DESCRIPTION

Map Scale: 1:3,200 if printed on A landscape (11" \times 8.5") sheet

GwC3 Gwinnett sandy clay loam, 6 to 10 percent slopes, severely eroded Pacolet sandy loam, 10 to 25 percent slopes

Wehadkee soils, 0 to 2 percent slopes, frequently flooded

Soil Map—Clayton, Fayette, and Henry Counties, Georgia

Web Soil Survey

National Cooperative Soil Survey

SOIL MAP

EROSION CONTROL LEGEND

FEMA FLOOD MAP - 13113C0118E

Ds2

TEMPORARY SEEDING -DETAIL A1/CE502

Ds3

Ds4

(Sd1-S

SILT FENCE -

TREE PROTECTION -

Ss

St

DATED 09/26/2008

Ds1

SCALE: NTS

TEMPORARY MULCHING -DETAIL A2/CE501

PERMANENT SEEDING -DETAIL A1/CE503

DISTURBED AREA STABILIZATION WITH SODDING -DETAIL C1/CE501

DETAIL C1/CE501

DUST CONTROL -DETAIL A1/CE501

Tr

DETAIL C1/CE504

SLOPE STABILIZATION -DETAIL B3/CE504

STORM DRAIN OUTLET PROTECTION - DETAIL A1/CE504

ACTIVITY SCHEDULE (FOR PERMITTING REFERENCE ONLY) TIME / 16 WEEKS ACTIVITY 3 | 4 | 5 | 6 | INSTALL SILT FENCE, CONSTRUCTION EXIT CLEARING AND GRUBBING INSTALL REMAINDER OF INITIAL PERIMTER CONTROLS INCLUDING SEDIMENT BASINS. CHECK DAMS, ROCK DAMS, DIVERSION BERMS ROCK FILTER, DOWN DRAINS, INLET SEDIMENT TRAPS, AND FILTER RINGS, DEMOLITION OF SURFACE PAVEMENT, OR ANY OTHER MISCELLANEOUS REQUIRED BMP, FENCES, EXISTING CULVERTS AND UTILITY UTILITY RELOCATION ROUGH GRADING OPERATIONS INSTALLATION OF PROPOSED CULVERTS FINAL PAVING AND GRADING PERMANENT SEEDING REMOVAL OF TEMPORARY EROSION AND SEDIMENT CONTROL MEASURES MAINTENANCE OF TEMPORARY EROSION AND SEDIMENT CONTROL MEASURES

> **DESIGN PROFESSIONAL:** CODY OWENBY, P.E. LEVEL II CERTIFICATION No.: 0000095439 EXPIRES: 09/10/2027

6/14/2022

Page 1 of 3



Know what's **below**. before you dig. **Dial 811** Or Call 800-282-7411

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EXP. 9/10/202 CLIENT INFORMATION

FAYETTE COUNTY

140 STONEWALL AVE W, STE 203 FAYETTEVILLE, GA. 30214

PROJECT NAME

CROSS CREEK TRAIL CULVERT REPLACEMENT

FAYETTE COUNTY, GA

DRAWING ISSUE

MDW/MIA DESIGNED BY: DRAWN BY: CHECKED BY: SUBMITTED BY: DATE: NOVEMBER 24, 2025

SHEET TITLE

1210496

EROSION AND SEDIMENT CONTROL **NOTES AND LEGEND**

PROJECT#

SHEET NUMBER

CE001

SHEET 9 OF 20 ORIGINAL SHEET SIZE:

SILT FENCE (SD1-TYPE "S"), TEMPORARY SEDIMENT BASINS, AND DIVERSION DITCHES WILL BE INSTALLED PRIOR TO CLEARING AND GRADING OPERATIONS TO KEEP SEDIMENT CONTAINED WITHIN THE SITE AS NECESSARY. DISTURBED AREA STABILIZATION SHALL BE STABILIZED WITH MULCH (Ds1), TEMPORARY SEEDING (Ds2), AND PERMANENT SEEDING (Ds3) AS NECESSARY. INLET SEDIMENT TRAP PROTECTION WILL BE USED TO HELP PREVENT SEDIMENT FROM ENTERING ANY EXISTING INLETS. SEDIMENT STORAGE OF 67 CY PER DISTURBED ACRE IS PROVIDED BY TEMPORARY SEDIMENT BASINS.

CRITICAL WORK ZONE:

ALL SLOPES 3:1 OR STEEPER AND HIGHER THAN 5 FEET, AND ALL SLOPES ADJACENT TO BUFFERS SHALL RECEIVE SURFACE ROUGHENING, AND EROSION CONTROL MATTING. SILT FENCING WILL BE USED TO PREVENT SEDIMENT FROM LEAVING THE DISTURBED AREA. INLET PROTECTION WILL BE USED TO PREVENT SEDIMENT FROM ENTERING THE STORM SEWER.

CONSTRUCTION PERIOD STORM WATER POLLUTANT CONTROL

SEDIMENTATION AND FUEL SPILLS ARE POTENTIAL SOURCES OF STORM WATER POLLUTION DURING THE CONSTRUCTION PROCESS. THESE POLLUTANTS WILL BE REMOVED AND/OR REDUCED VIA THE BMP'S CONTAINED WITHIN THIS PLAN

STABILIZATION MEASURES:

THE STABILIZATION MEASURES SHOWN ON THESE PLANS HAVE BEEN DESIGNED TO STABILIZE THE DISTURBED AREAS FOLLOWING THE TEMPORARY OR PERMANENT COMPLETION OF CONSTRUCTION. ALL EXPOSED AREAS SHALL BE STABILIZED WITH TEMPORARY MULCHING (DS1) IMMEDIATELY AFTER TRENCHING IF THEY ARE TO REMAIN INACTIVE FOR 14 DAYS OR MORE. ALL DISTURBED AREAS SHALL BE STABILIZED WITH TEMPORARY (DS2) OR PERMANENT (DS3) VEGETATION AS INDICATED ON THE PLAN. SLOPES GREATER 3:1 ARE TO BE STABILIZED WITH EROSION CONTROL MATTING (MB). DUST CONTROL (DU) SHALL ALSO BE PROVIDED AS NEEDED DURING GRADING ACTIVITIES. SEE EROSION, SEDIMENTATION, AND POLLUTION CONTROL (ESPCP) DETAIL SHEETS FOR MORE DETAILS REGARDING THESE STABILIZATION MEASURES.

STABILIZATION MEASURES SHALL BE INITIATED AS SOON AS PRACTICABLE IN PORTIONS OF THE SITE WHERE CONSTRUCTION ACTIVITIES HAVE TEMPORARILY OR PERMANENTLY CEASED, BUT IN NO CASE MORE THAN 14 DAYS AFTER THE CONSTRUCTION ACTIVITY IN THAT PORTION OF THE SITE HAS TEMPORARILY OR PERMANENTLY CEASED, EXCEPT:

WHERE THE INITIATION OF STABILIZATION MEASURES BY THE 14TH DAY AFTER CONSTRUCTION ACTIVITY TEMPORARILY OR PERMANENTLY CEASED IS PRECLUDED BY SNOW COVER OR OTHER ADVERSE WEATHER CONDITIONS, STABILIZATION MEASURES SHALL BE INITIATED AS SOON AS PRACTICAL.

WHERE CONSTRUCTION ACTIVITY WILL RESUME ON A PORTION OF THE SITE WITHIN 21 DAYS FROM WHEN ACTIVITIES CEASED (E.G. THE TOTAL TIME PERIOD THAT CONSTRUCTION ACTIVITY IS TEMPORARILY CEASED IS LESS THAN 21 DAYS) THEN STABILIZATION MEASURES DO NOT HAVE TO BE INITIATED ON THAT PORTION OF THE SITE BY THE 14TH DAY AFTER CONSTRUCTION ACTIVITY TEMPORARILY CEASED.

KEEPING PLANS CURRENT:

THE PRIMARY, SECONDARY OR TERTIARY PERMITTEES, AS APPLICABLE, SHALL AMEND THEIR PLAN WHENEVER THERE IS A CHANGE IN DESIGN, CONSTRUCTION, OPERATION , OR MAINTENANCE, WHICH HAS A SIGNIFICANT EFFECT ON BMPS WITH A HYDRAULIC COMPONENT (I.E., THOSE BMPS WHERE THE DESIGN IS BASED UPON RAINFALL INTENSITY, DURATION AND RETURN FREQUENCY STORMS) OR IF THE PLAN PROVES TO BE INEFFECTIVE IN ELIMINATING OR SIGNIFICANTLY MINIMIZING POLLUTANTS FROM SOURCES IDENTIFIED UNDER PART IV.D.3. OF THIS PERMIT. AMENDMENTS TO THE PLAN MUST BE CERTIFIED BY A DESIGN PROFESSIONAL AS PROVIDED IN THIS PERMIT. SECONDARY PERMITTEES MUST NOTIFY THE PRIMARY PERMITTEE WITHIN 24-HOURS OF BECOMING AWARE OF ANY SUSPECTED BMP DESIGNED DEFICIENCIES WHICH ARE NOT EFFECTIVE IN CONTROLLING THE DISCHARGE OF POLLUTANTS FROM THE SECONDARY PERMITTEE'S SITE. THE PRIMARY PERMITTEE MUST EVALUATE WHETHER THESE DEFICIENCIES EXIST WITHIN 48-HOURS OF SUCH NOTICE, AND IF THESE DEFICIENCIES ARE FOUND TO EXIST MUST AMEND THE PLAN IN ACCORDANCE WITH THIS PARAGRAPH TO ADDRESS THOSE DEFICIENT BMPS WITHIN SEVEN (7) DAYS OF BEING NOTIFIED BY THE SECONDARY PERMITTEE. WHEN THE PLAN IS AMENDED, THE PRIMARY PERMITTEE MUST NOTIFY AND PROVIDE A COPY OF THE AMENDMENT TO ALL AFFECTED SECONDARY PERMITTEES WITHIN THIS SEVEN (7) DAY PERIOD. THE SECONDARY PERMITTEE(S) MUST IMPLEMENT ANY NEW PLAN REQUIREMENTS AFFECTING THEIR SITE(S) WITHIN 48-HOURS OF NOTIFICATION BY THE PRIMARY PERMITTEE. NOTWITHSTANDING THE FOREGOING, THE PRIMARY OR TERTIARY PERMITTEE REMAINS RESPONSIBLE FOR INSURING THAT THE PLAN, AS APPROPRIATE, MEETS THE REQUIREMENTS OF THIS PERMIT.

PROPER OPERATION AND MAINTENANCE:

THE PERMITTEE SHALL AT ALL TIMES PROPERLY OPERATE AND MAINTAIN ALL FACILITIES AND SYSTEMS OF TREATMENT AND CONTROL (AND RELATED APPURTENANCES) WHICH ARE INSTALLED OR USED BY THE PERMITTEE TO ACHIEVE COMPLIANCE WITH THE CONDITIONS OF THIS PERMIT AND WITH THE REQUIRED PLANS. PROPER OPERATION AND MAINTENANCE ALSO INCLUDES ADEQUATE LABORATORY CONTROLS AND APPROPRIATE QUALITY ASSURANCE PROCEDURES. PROPER OPERATION AND MAINTENANCE REQUIRES THE OPERATION OF BACKUP OR AUXILIARY FACILITIES OR SIMILAR SYSTEMS, INSTALLED BY AN PERMITTEE ONLY WHEN NECESSARY TO ACHIEVE COMPLIANCE WITH THE CONDITIONS OF THE PERMIT.

EROSION AND SEDIMENT CONTROL MEASURES WILL BE MAINTAINED AT ALL TIMES. IF FULL IMPLEMENTATION OF THE APPROVED PLAN DOES NOT PROVIDE FOR EFFECTIVE EROSION AND SEDIMENT CONTROL, ADDITIONAL EROSION AND SEDIMENT CONTROL MEASURES SHALL BE IMPLEMENTED TO CONTROL OR TREAT THE SEDIMENT SOURCE.

REFER TO THE DETAILS CONTAINED WITHIN THIS PLAN SET FOR ADDITIONAL MAINTENANCE INSTRUCTION.

NON-STORM WATER DISCHARGES:

NON-STORM WATER DISCHARGES (DISCHARGES FROM FIRE FIGHTING ACTIVITIES, FIRE HYDRANT FLUSHING, POTABLE WATER SOURCES INCLUDING WATER LINE FLUSHING, IRRIGATION DRAINAGE, AIR CONDITIONING CONDENSATE, SPRINGS, UNCONTAMINATED GROUNDWATER, AND FOUNDATION OR FOOTING DRAINS WHERE FLOWS ARE NOT CONTAMINATED WITH PROCESS MATERIALS OR POLLUTANTS) THAT ARE COMBINED WITH STORM WATER DISCHARGES ASSOCIATED WITH CONSTRUCTION ACTIVITY SHALL BE DISCHARGED TO THE PROPOSED STORM DRAINAGE SYSTEM AND ROUTED THROUGH THE EROSION AND SEDIMENTATION CONTROLS IDENTIFIED WITHIN THIS PLAN. NOTIFY THE LICENSED PROFESSIONAL WHO PREPARED THIS PLAN IF THIS IS NOT POSSIBLE.

WASTE MATERIALS AND DISPOSAL

ALL WASTE MATERIALS SHALL BE COLLECTED AND STORED IN A SECURELY LIDDED METAL DUMPSTER OR OTHER APPROPRIATE WASTE MANAGEMENT FACILITY PERMISSIBLE UNDER GAR PERMIT NO. 100001. WASTE MANAGEMENT FACILITIES SHALL MEET ALL SOLID WASTE MANAGEMENT REGULATIONS. ALL TRASH AND CONSTRUCTION DEBRIS FROM THE SITE SHALL BE DEPOSITED IN THE WASTE MANAGEMENT FACILITIES. WASTE MANAGEMENT FACILITIES SHALL BE EMPTIED A MINIMUM OF ONCE PER WEEK OR MORE OFTEN IF NECESSARY AND TRASH SHALL BE HAULED AS REQUIRED BY LOCAL REGULATIONS. NO CONSTRUCTION WASTE SHALL BE BURIED ON-SITE.

ALL PERSONNEL SHALL BE INSTRUCTED ON PROPER PROCEDURES FOR WASTE DISPOSAL. A NOTICE STATING THESE PRACTICES SHALL BE POSTED AT THE JOB SITE AND THE CONTRACTOR SHALL BE RESPONSIBLE FOR SEEING THAT THESE PROCEDURES ARE FOLLOWED.

LOCATE WASTE COLLECTION AREAS AWAY FROM STREETS, GUTTERS, WATERCOURSES AND STORM DRAINS. WASTE COLLECTION AREAS, SUCH AS DUMPSTERS, ARE OFTEN BEST LOCATED NEAR CONSTRUCTION SITE ENTRANCES TO MINIMIZE TRAFFIC ON DISTURBED SOILS.

HAZARDOUS WASTES:

ALL HAZARDOUS WASTE MATERIALS SHALL BE DISPOSED OF IN THE MANNER AS REQUIRED BY LOCAL, STATE, AND/OR FEDERAL REGULATIONS AND BY THE MANUFACTURER OF SUCH PRODUCTS. THE JOB SITE SUPERINTENDENT, WHO WILL ALSO BE RESPONSIBLE FOR SEEING THAT THESE PRACTICES ARE FOLLOWED, SHALL INSTRUCT SITE PERSONNEL IN THESE PRACTICES. MATERIAL SAFETY DATA SHEETS (MSDS'S) FOR EACH SUBSTANCE WITH HAZARDOUS PROPERTIES THAT IS USED ON THE JOB SITE SHALL BE OBTAINED AND USED FOR THE PROPER MANAGEMENT OF POTENTIAL WASTES THAT MAY RESULT FROM THESE PRODUCTS. AN MSDS SHALL BE POSTED IN THE IMMEDIATE AREA WHERE SUCH PRODUCT IS STORED AND/OR USED AND ANOTHER COPY OF EACH MSDS SHALL BE MAINTAINED IN THE EROSION SEDIMENTATION AND POLLUTION CONTROL PLAN (ESPCP) FILE AT THE JOB SITE CONSTRUCTION TRAILER OFFICE. EACH EMPLOYEE WHO HANDLES A SUBSTANCE WITH HAZARDOUS PROPERTIES WILL BE INSTRUCTED ON THE USE OF MSDS SHEETS AND THE SPECIFIC INFORMATION IN THE APPLICABLE MSDS FOR THE PRODUCT HE/SHE IS USING, PARTICULARLY REGARDING SPILL CONTROL TECHNIQUES.

THE CONTRACTOR WILL IMPLEMENT THE SPILL PREVENTION CONTROL AND COUNTERMEASURES (SPCC) PLAN FOUND WITHIN THIS ESPCP AND WILL TRAIN ALL PERSONNEL IN THE PROPER CLEANUP AND HANDLING OF SPILLED MATERIALS. NO SPILLED HAZARDOUS MATERIALS OR HAZARDOUS WASTES SHALL BE ALLOWED TO COME IN CONTACT WITH STORM WATER DISCHARGES. IF SUCH CONTACT OCCURS, THE STORM WATER DISCHARGE SHALL BE CONTAINED ON SITE UNTIL APPROPRIATE MEASURES IN COMPLIANCE WITH STATE AND FEDERAL REGULATIONS ARE TAKEN TO DISPOSE OF SUCH CONTAMINATED STORM WATER. IT SHALL BE THE RESPONSIBILITY OF THE JOB SITE SUPERINTENDENT TO PROPERLY TRAIN ALL PERSONNEL IN THE USE OF THE SPCC PLAN.

NOTHING IN THIS PERMIT SHALL BE CONSTRUED TO PRECLUDE THE INSTITUTION OF ANY LEGAL ACTION OR RELIEVE THE PERMITTEE FROM ANY RESPONSIBILITIES, LIABILITIES, OR PENALTIES TO WHICH THE PERMITTEE IS OR MAY BE SUBJECT UNDER THE GEORGIA HAZARDOUS WASTE MANAGEMENT ACT, O.C.G.A. § 12-8-60, ET SEQ. OR UNDER CHAPTER 14 OF TITLE 12 OF THE OFFICIAL CODE OF GEORGIA ANNOTATED; NOR IS THE OPERATOR RELIEVED FROM ANY RESPONSIBILITIES, LIABILITIES OR PENALTIES TO WHICH THE PERMITTEE IS OR MAY BE SUBJECT UNDER SECTION 311 OF THE CLEAN WATER ACT OR SECTION 106 OF COMPREHENSIVE ENVIRONMENTAL RESPONSE COMPENSATION AND LIABILITY ACT.

SANITARY WASTES:

ALL PERMITTEES SHALL ENSURE THAT THIS PLAN IS IN COMPLIANCE WITH APPLICABLE STATE AND/OR LOCAL WASTE DISPOSAL, SANITARY SEWER, OR SEPTIC SYSTEM REGULATIONS.

A MINIMUM OF ONE PORTABLE SANITARY UNIT SHALL BE PROVIDED FOR EVERY TEN (10) WORKERS ON THE SITE. ALL SANITARY WASTE SHALL BE COLLECTED FROM THE PORTABLE UNITS A MINIMUM OF ONE TIME PER WEEK BY A LICENSED PORTABLE FACILITY PROVIDER IN COMPLETE COMPLIANCE WITH THE LOCAL STATE REGULATIONS.

ALL SANITARY WASTE UNITS SHALL BE LOCATED IN AN AREA WHERE THE LIKELIHOOD OF THE UNIT CONTRIBUTING TO STORM WATER DISCHARGE IS NEGLIGIBLE. ADDITIONAL CONTAINMENT OF BMP'S SHALL BE IMPLEMENTED AS NECESSARY, SUCH AS GRAVEL BAGS OR SPECIFICALLY DESIGNED PLASTIC SKID CONTAINERS AROUND THE BASE, TO PREVENT WASTE FROM CONTRIBUTING TO STORM WATER DISCHARGES. THE LOCATION OF SANITARY WASTE UNITS MUST BE IDENTIFIED ON THE EROSION CONTROL PLAN GRADING PHASE BY THE CONTRACTOR ONCE THE LOCATIONS HAVE BEEN DETERMINED.

OFFSITE VEHICLE TRACKING / DUST CONTROL:

OFF-SITE VEHICLE TRACKING OF DIRT, SOILS, AND SEDIMENTS AND THE GENERATION OF DUST SHALL BE MINIMIZED OR ELIMINATED TO THE MAXIMUM EXTENT PRACTICAL. A STABILIZED CONSTRUCTION EXIT (CO) SHALL BE PROVIDED TO REDUCE VEHICLE TRACKING OF SEDIMENT. SEE ESPCP PLAN AND DETAIL SHEETS FOR THE CONSTRUCTION EXIT LOCATIONS AND DETAIL. THE PAVED STREET ADJACENT TO THE CONSTRUCTION EXIT SHALL BE INSPECTED DAILY BY A REPRESENTATIVE OF THE SITE CONTRACTOR FOR TRACKING OF MUD, DIRT, OR ROCK. DUMP TRUCKS HAULING MATERIAL FROM THE CONSTRUCTION SITE SHALL BE COVERED WITH A TARPAULIN. DUST CONTROL (DU) SHALL BE APPLIED AS NECESSARY TO PREVENT SURFACE AND AIR MOVEMENT OF DUST.

INVENTORY FOR POLLUTION PREVENTION PLAN

THE FOLLOWING MATERIALS ARE EXPECTED TO BE ONSITE DURING CONSTRUCTION: CONCRETE PRODUCTS, ASPHALT, PETROLEUM BASED FUELS AND LUBRICANTS FOR EQUIPMENT, TAR, METAL BUILDING MATERIALS, LUMBER, SHEET ROCK, FLOOR COVERINGS, ELECTRICAL WIRE AND FIXTURES, PAINTS/STAINS/FINISHING TREATMENTS, PAINT SOLVENTS, ADDITIVES FOR SOIL STABILIZATION, CLEANING SOLVENTS, PESTICIDES, FERTILIZERS, HERBICIDES, CRUSHED STONE, PLASTIC AND METAL PIPES.

SPILL PREVENTION

PRACTICES SUCH AS GOOD HOUSEKEEPING, PROPER HANDLING OF HAZARDOUS PRODUCTS AND PROPER SPILL CONTROL PRACTICES WILL BE FOLLOWED TO REDUCE THE RISK OF SPILLS AND SPILLS FROM DISCHARGING INTO STORM WATER RUNOFF.

GOOD HOUSEKEEPING

QUANTITIES OF PRODUCTS STORED ONSITE WILL BE LIMITED TO THE AMOUNT NEEDED FOR THE JOB.

- A. PRODUCTS AND MATERIALS WILL BE STORED IN A NEAT, ORDERLY MANNER IN APPROPRIATE CONTAINERS PROTECTED FROM RAINFALL, WHERE POSSIBLE.
- B. PRODUCTS WILL BE KEPT IN THEIR ORIGINAL CONTAINERS WITH MANUFACTURER LABELS LEGIBLE AND VISIBLE.
- C. PRODUCT MIXING, PRODUCT DISPOSAL, AND DISPOSAL OF PRODUCT CONTAINERS WILL BE ACCORDING TO THE MANUFACTURER'S RECOMMENDATIONS.
- D. THE CONTRACTOR WILL INSPECT SUCH MATERIALS TO ENSURE PROPER USE, STORAGE AND DISPOSAL.

EROSION, SEDIMENTATION, AND POLLUTION CONTROL PLAN GENERAL NOTES (IN CONFORMANCE WITH STATE OF GEORGIA GENERAL NPDES PERMIT NO. GAR 100001)

PRODUCT SPECIFIC PRACTICES

PETROLEUM BASED PRODUCTS - CONTAINERS FOR PRODUCTS SUCH AS FUELS, LUBRICANTS AND TARS WILL BE INSPECTED DAILY FOR LEAKS AND SPILLS. THIS INCLUDES ON-SITE VEHICLE AND MACHINERY DAILY INSPECTIONS AND REGULAR PREVENTATIVE MAINTENANCE OF SUCH EQUIPMENT. EQUIPMENT MAINTENANCE AREAS WILL BE LOCATED AWAY FROM STATE WATER, NATURAL DRAINS AND STORM WATER DRAINAGE INLETS. IN ADDITION, TEMPORARY FUELING TANKS SHALL HAVE A SECONDARY CONTAINMENT LINER TO PREVENT/MINIMIZE SITE CONTAINMENT. DISCHARGE OF OILS, FUELS AND LUBRICANTS IS PROHIBITED. PROPER DISPOSAL METHODS WILL INCLUDE COLLECTION IN A SUITABLE CONTAINER AND DISPOSAL AS REQUIRED BY LOCAL AND STATE REGULATIONS.

PAINTS/FINISHES/SOLVENTS - ALL PRODUCTS WILL BE STORED IN TIGHTLY SEALED ORIGINAL CONTAINERS WHEN NOT IN USE. EXCESS PRODUCT WILL NOT BE DISCHARGED INTO THE STORM WATER COLLECTION SYSTEM. EXCESS PRODUCT, MATERIALS USED WITH THESE PRODUCTS, AND PRODUCT CONTAINERS WILL BE DISPOSED ACCORDING TO MANUFACTURER'S SPECIFICATIONS AND RECOMMENDATIONS.

CONCRETE/MASONRY - NO CONCRETE TRUCKS WILL BE ALLOWED TO WASH OUT OR DISCHARGE SURPLUS CONCRETE OR DRUM WASH WATER ON SITE. THE CONCRETE PROVIDER HAS RESPONSIBILITY TO ENSURE APPROPRIATE TRAINING HAS BEEN PROVIDED TO THEIR TRUCK DRIVERS, AND MUST PROVIDE APPROPRIATE DETAILS AND RESOURCES TO ENABLE THEM TO COMPLETE A DELIVERY WITHOUT CAUSING POLLUTION. CHUTES, BARRELS, WHEELBARROWS AND OTHER EQUIPMENT MUST BE RINSED IN THE SITE WASH-DOWN AREA. SWEEP OR SHOVEL ANY SPILLS THAT OCCUR AND ALLOW RESIDUE TO SET BEFORE REMOVING. THE HARDENED RESIDUE MAY THEN BE PLACED IN A DESIGNATED CONCRETE/MASONRY RECYCLING BIN ON SITE. DO NOT WASH CONCRETE/MASONRY INTO STORM DRAINS, OPEN DITCHES, STREETS, OR STREAMS. TRUCKS SHOULD NOT TRACK ANY CONCRETE OR MUD AND SEDIMENT OFF SITE.

FERTILIZER/HERBICIDES - THESE PRODUCTS WILL BE APPLIED AT RATES THAT DO NOT EXCEED THE MANUFACTURER'S SPECIFICATIONS, THE CROP ESTABLISHMENT GUIDELINES, OR THE SPECIFICATIONS CONTAINED WITHIN THE GSWCC MANUAL FOR EROSION AND SEDIMENT CONTROL IN GEORGIA.

SPILL PREVENTION CONTROL AND COUNTERMEASURES (SPCC) PLAN:

- A. LOCAL, STATE, AND MANUFACTURER'S RECOMMENDED METHODS FOR SPILL CLEANUP SHALL BE CLEARLY POSTED AND PROCEDURES SHALL BE MADE AVAILABLE TO SITE PERSONNEL.
- B. MATERIAL AND EQUIPMENT NECESSARY FOR SPILL CLEANUP SHALL BE KEPT IN THE MATERIAL STORAGE AREAS. TYPICAL MATERIALS AND EQUIPMENT INCLUDES, BUT IS NOT LIMITED TO, BROOMS, DUSTPANS, MOPS, RAGS, GLOVES, GOGGLES, CAT LITTER, SAND, SAWDUST, AND PROPERLY LABELED PLASTIC AND METAL WASTE CONTAINERS.
- C. SPILL PREVENTION PRACTICES AND PROCEDURES SHALL BE REVIEWED AFTER A SPILL AND ADJUSTED AS NECESSARY TO PREVENT FUTURE SPILLS.
- D. ALL SPILLS WILL BE CLEANED IMMEDIATELY UPON DISCOVERY. ALL SPILLS SHALL BE REPORTED AS REQUIRED BY LOCAL, STATE AND FEDERAL REGULATIONS.
- E. THE DISCHARGE OF HAZARDOUS SUBSTANCES OR OIL IN THE STORM WATER DISCHARGE(S) FROM A SITE SHALL BE PREVENTED.
- F. WHERE A RELEASE CONTAINING A HAZARDOUS SUBSTANCE IN AN AMOUNT EQUAL TO OR IN EXCESS OF A REPORTING QUANTITY ESTABLISHED UNDER EITHER GEORGIA'S OIL OR HAZARDOUS MATERIAL SPILLS OR RELEASES ACT (O.C.G.A. SEC. 12-14-2, ET SEQ.), 40 CFR 117, OR 40 CFR 302 OCCURS DURING A 24-HOUR PERIOD, THE PERMITTEE IS REQUIRED TO NOTIFY EPD AT (404) 656-4863 OR (800) 241-4113 AND THE NATIONAL RESPONSE CENTER (NRC) AT (800) 424-8802 IN ACCORDANCE WITH THE REQUIREMENTS OF GEORGIA'S OIL OR HAZARDOUS MATERIAL SPILLS OR RELEASES ACT (O.C.G.A. SEC. 12-14-2, ET SEQ.), 40 CFR 117, AND 40 CFR 302 AS SOON AS HE HAS KNOWLEDGE OF THE DISCHARGE.
- G. FOR SPILLS THAT IMPACT SURFACE WATER (LEAVE A SHEEN ON SURFACE WATER) OR SPILLS OF AN UNKNOWN AMOUNT, THE NATIONAL RESPONSE CENTER (NRC) SHALL BE CONTACTED WITHIN 24 HOURS AT (800) 424-8802.
- H. FOR SPILLS GREATER THAN 25 GALLONS AND NO SURFACE WATER IMPACTS, THE GEORGIA EPD SHALL BE CONTACTED WITHIN 24 HOURS AT (404) 656-4863 OR (800) 241-4113.
- I. FOR SPILLS LESS THAN 25 GALLONS AND NO SURFACE WATER IMPACTS, THE SPILL SHALL BE CLEANED AND LOCAL AGENCIES SHALL BE CONTACTED AS REQUIRED.
- J. GENERAL NPDES PERMIT NO. GAR 100002 DOES NOT AUTHORIZE THE DISCHARGE OF HAZARDOUS SUBSTANCES OR OIL RESULTING FROM AN ON-SITE SPILL.

THE CONTRACTOR SHALL NOTIFY THE LICENSED PROFESSIONAL WHO PREPARED THIS PLAN IF MORE THAN 1,320 GALLONS OF PETROLEUM IS STORED ONSITE (THIS INCLUDES CAPACITIES OF EQUIPMENT) OR IF ANY ONE PIECE OF EQUIPMENT HAS A CAPACITY GREATER THAN 660 GALLONS. THE CONTRACTOR WILL NEED A SPILL PREVENTION CONTAINMENT AND COUNTERMEASURES PLAN PREPARED BY A LICENSED PROFESSIONAL.

DESIGN PROFESSIONAL: CODY OWENBY, P.E. LEVEL II CERTIFICATION No.: 0000095439 EXPIRES: 09/10/2027



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CLIENT INFORMATION

FAYETTE COUNTY 140 STONEWALL AVE W, STE 203 FAYETTEVILLE, GA. 30214

PROJECT NAME

CROSS CREEK
TRAIL
CULVERT
REPLACEMENT

FAYETTE COUNTY, GA

DRAWING ISSUE

NOIL

DESIGNED BY: MDW/MIA
DRAWN BY: MDW
CHECKED BY: COA
SUBMITTED BY: TT
DATE: NOVEMBER 24, 2025

SHEET TITLE

1210496

EROSION AND SEDIMENT CONTROL NOTES AND LEGEND

PROJECT#

SHEET NUMBER

CE002

SHEET 10 OF 20

ORIGINAL SHEET SIZE:
22" X 34"

Contour Intervals, ft. 1 or 2 2,5 or 10 N/A 39 Use of alternative BMPs whose performance has been documented to be equivalent to or superior to conventional BMPs as certified by a Design Professional (unless disapproved by GAEPD or the Georgia Soil and Water Conservation Commission). Please refer to the Alternative BMP Guidance Document found at **CE Plan** Y 41 Delineation of the applicable 25-foot or 50-foot undisturbed buffers adjacent to state waters and any additional buffers required by the Local Issuing Authority. Clearly note and delineate all areas of impact. **CE Plan** Y 42 Delineation of on-site wetlands and all state waters located on and within 200 feet of the project site. **CE Plan** Y 43 Delineation and acreage of contributing drainage basins on the project site. N/A | N/A | 44 Provide hydrology study and maps of drainage basins for both the pre- and post-developed conditions. * CG201 Y 45 An estimate of the runoff coefficient or peak discharge flow of the site prior to and after construction activities are N/A N/A 46 Storm-drain pipe and weir velocities with appropriate outlet protection to accommodate discharges without CE101 Y 49 Provide a minimum of 67 cubic yards of sediment storage per acre drained using a temporary sediment basin, retrofitted detention pond, and/or excavated inlet sediment traps for each common drainage location. Sediment storage volume must be in place prior to and during all land disturbance activities until final stabilization of the site has been achieved. A written justification explaining the decision to use equivalent controls when a sediment basin is not attainable must be included in the Plan for each common drainage location in which a sediment basin is not provided. A written justification as to why 67 cubic yards of storage is not attainable must also be given. Worksheets from the Manual included for structural BMPs and all calculations used by the storage design professional to obtain the required sediment when using equivalent controls. When discharging from sediment basins and impoundments, permittees are required to utilize outlet structures that withdraw water from the surface, unless infeasible. If outlet structures that withdraw water from the surface are not feasible, a written justification explaining this decision must be included in the Plan. CE Plan Y 50 Location of Best Management Practices that are consistent with and no less stringent than the Manual for Erosion and Sediment Control in Georgia. Use uniform coding symbols from the Manual, Chapter 6, with CE-50X Y 51 Provide detailed drawings for all structural practices. Specifications must, at a minimum, meet the guidelines set CE501 Y 52 Provide vegetative plan, noting all temporary and permanent vegetative practices. Include species, planting dates and seeding, fertilizer, lime and mulching rates. Vegetative plan shall be site specific for appropriate time of the year that seeding will take place and for the appropriate geographic region of Georgia. * If using this checklist for a project that is less than 1 acre and not part of a common development but within 200 ft of a perennial stream, the * checklist items would be N/A.

Effective January 1, 2024

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CLIENT INFORMATION

FAYETTE COUNTY

140 STONEWALL AVE W, STE 203 FAYETTEVILLE, GA. 30214

PROJECT NAME

CROSS CREEK **TRAIL CULVERT** REPLACEMENT

FAYETTE COUNTY, GA

DRAWING ISSUE

MDW/MIA **DESIGNED BY:** DRAWN BY CHECKED BY: SUBMITTED BY: DATE: NOVEMBER 24, 2025 1210496 PROJECT#

SHEET TITLE

EROSION AND SEDIMENT CONTROL **NOTES AND LEGEND**

SHEET NUMBER

CE003

ORIGINAL SHEET SIZE: 22" X 34"

SHEET 11 OF 20

DESIGN PROFESSIONAL CODY OWENBY, P.E. LEVEL II CERTIFICATION No.: 0000095439 EXPIRES: 09/10/2027




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EXP. 9/10/2027

FAYETTE COUNTY 140 STONEWALL AVE W, STE 203 FAYETTEVILLE, GA. 30214

PROJECT NAME

CROSS CREEK TRAIL CULVERT REPLACEMENT

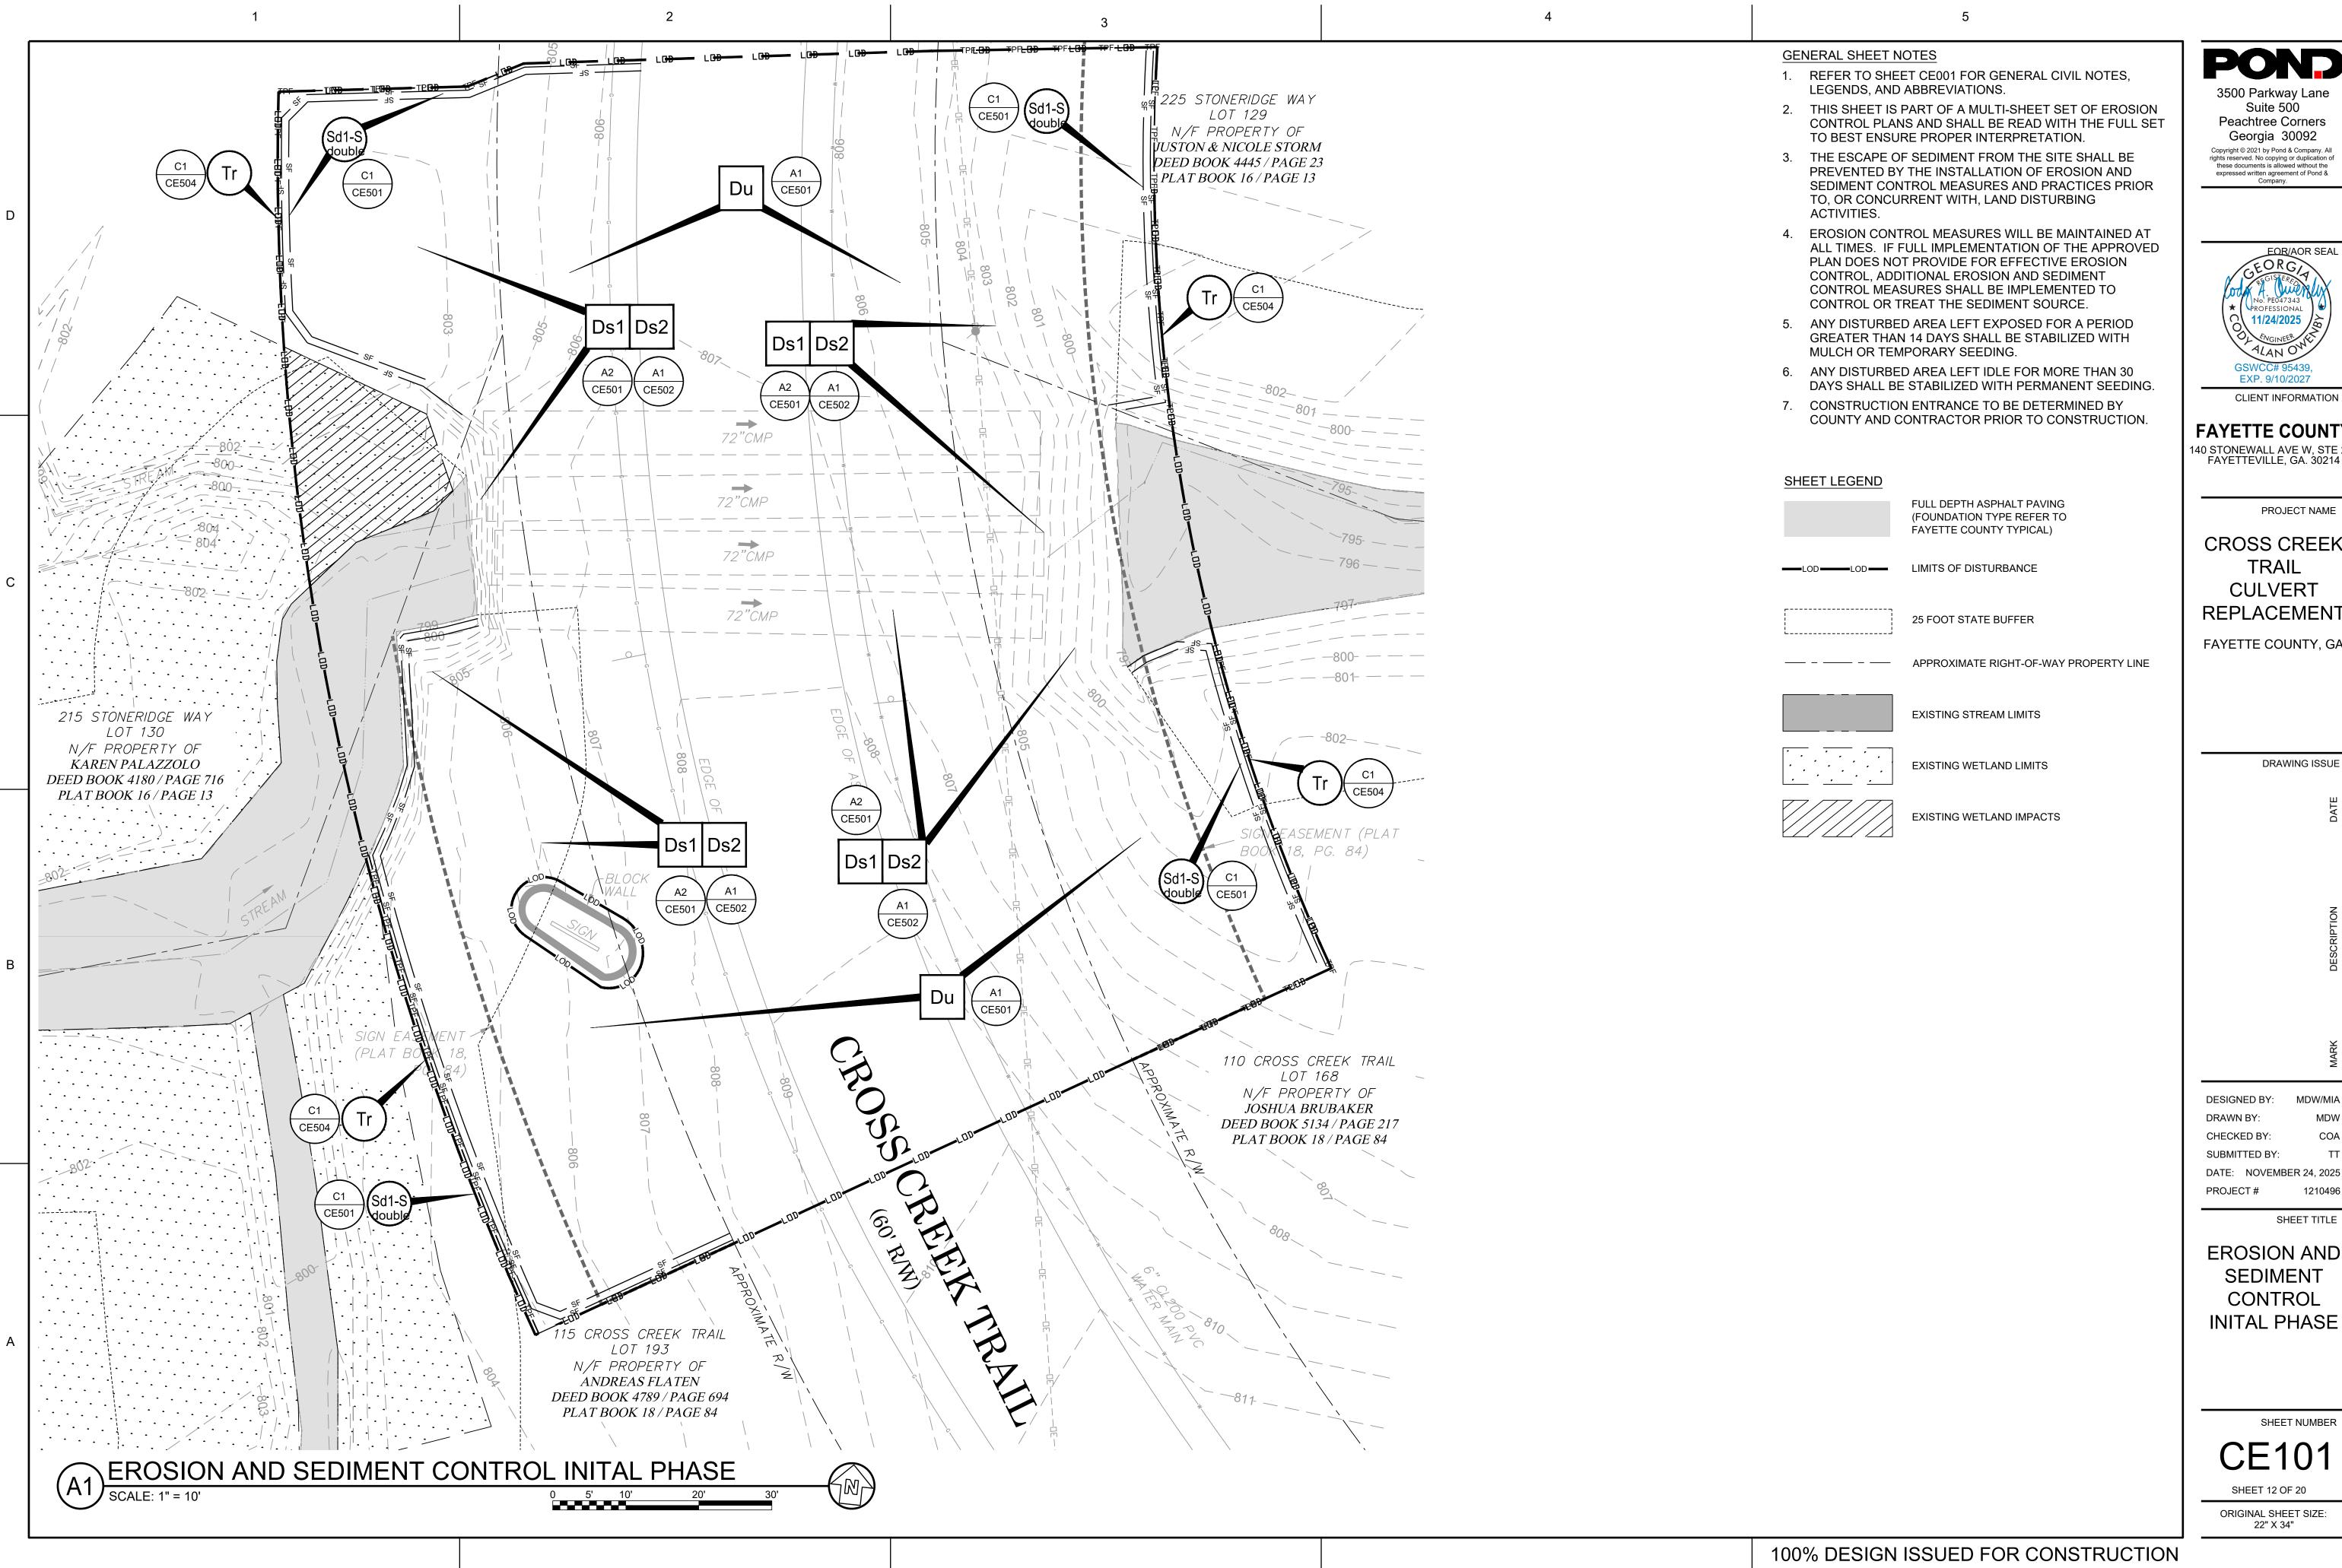FAYETTE COUNTY, GA

DRAWING ISSUE


DATE: NOVEMBER 24, 2025

SHEET TITLE

EROSION AND SEDIMENT CONTROL **INITAL PHASE**

CE101

ORIGINAL SHEET SIZE: 22" X 34"

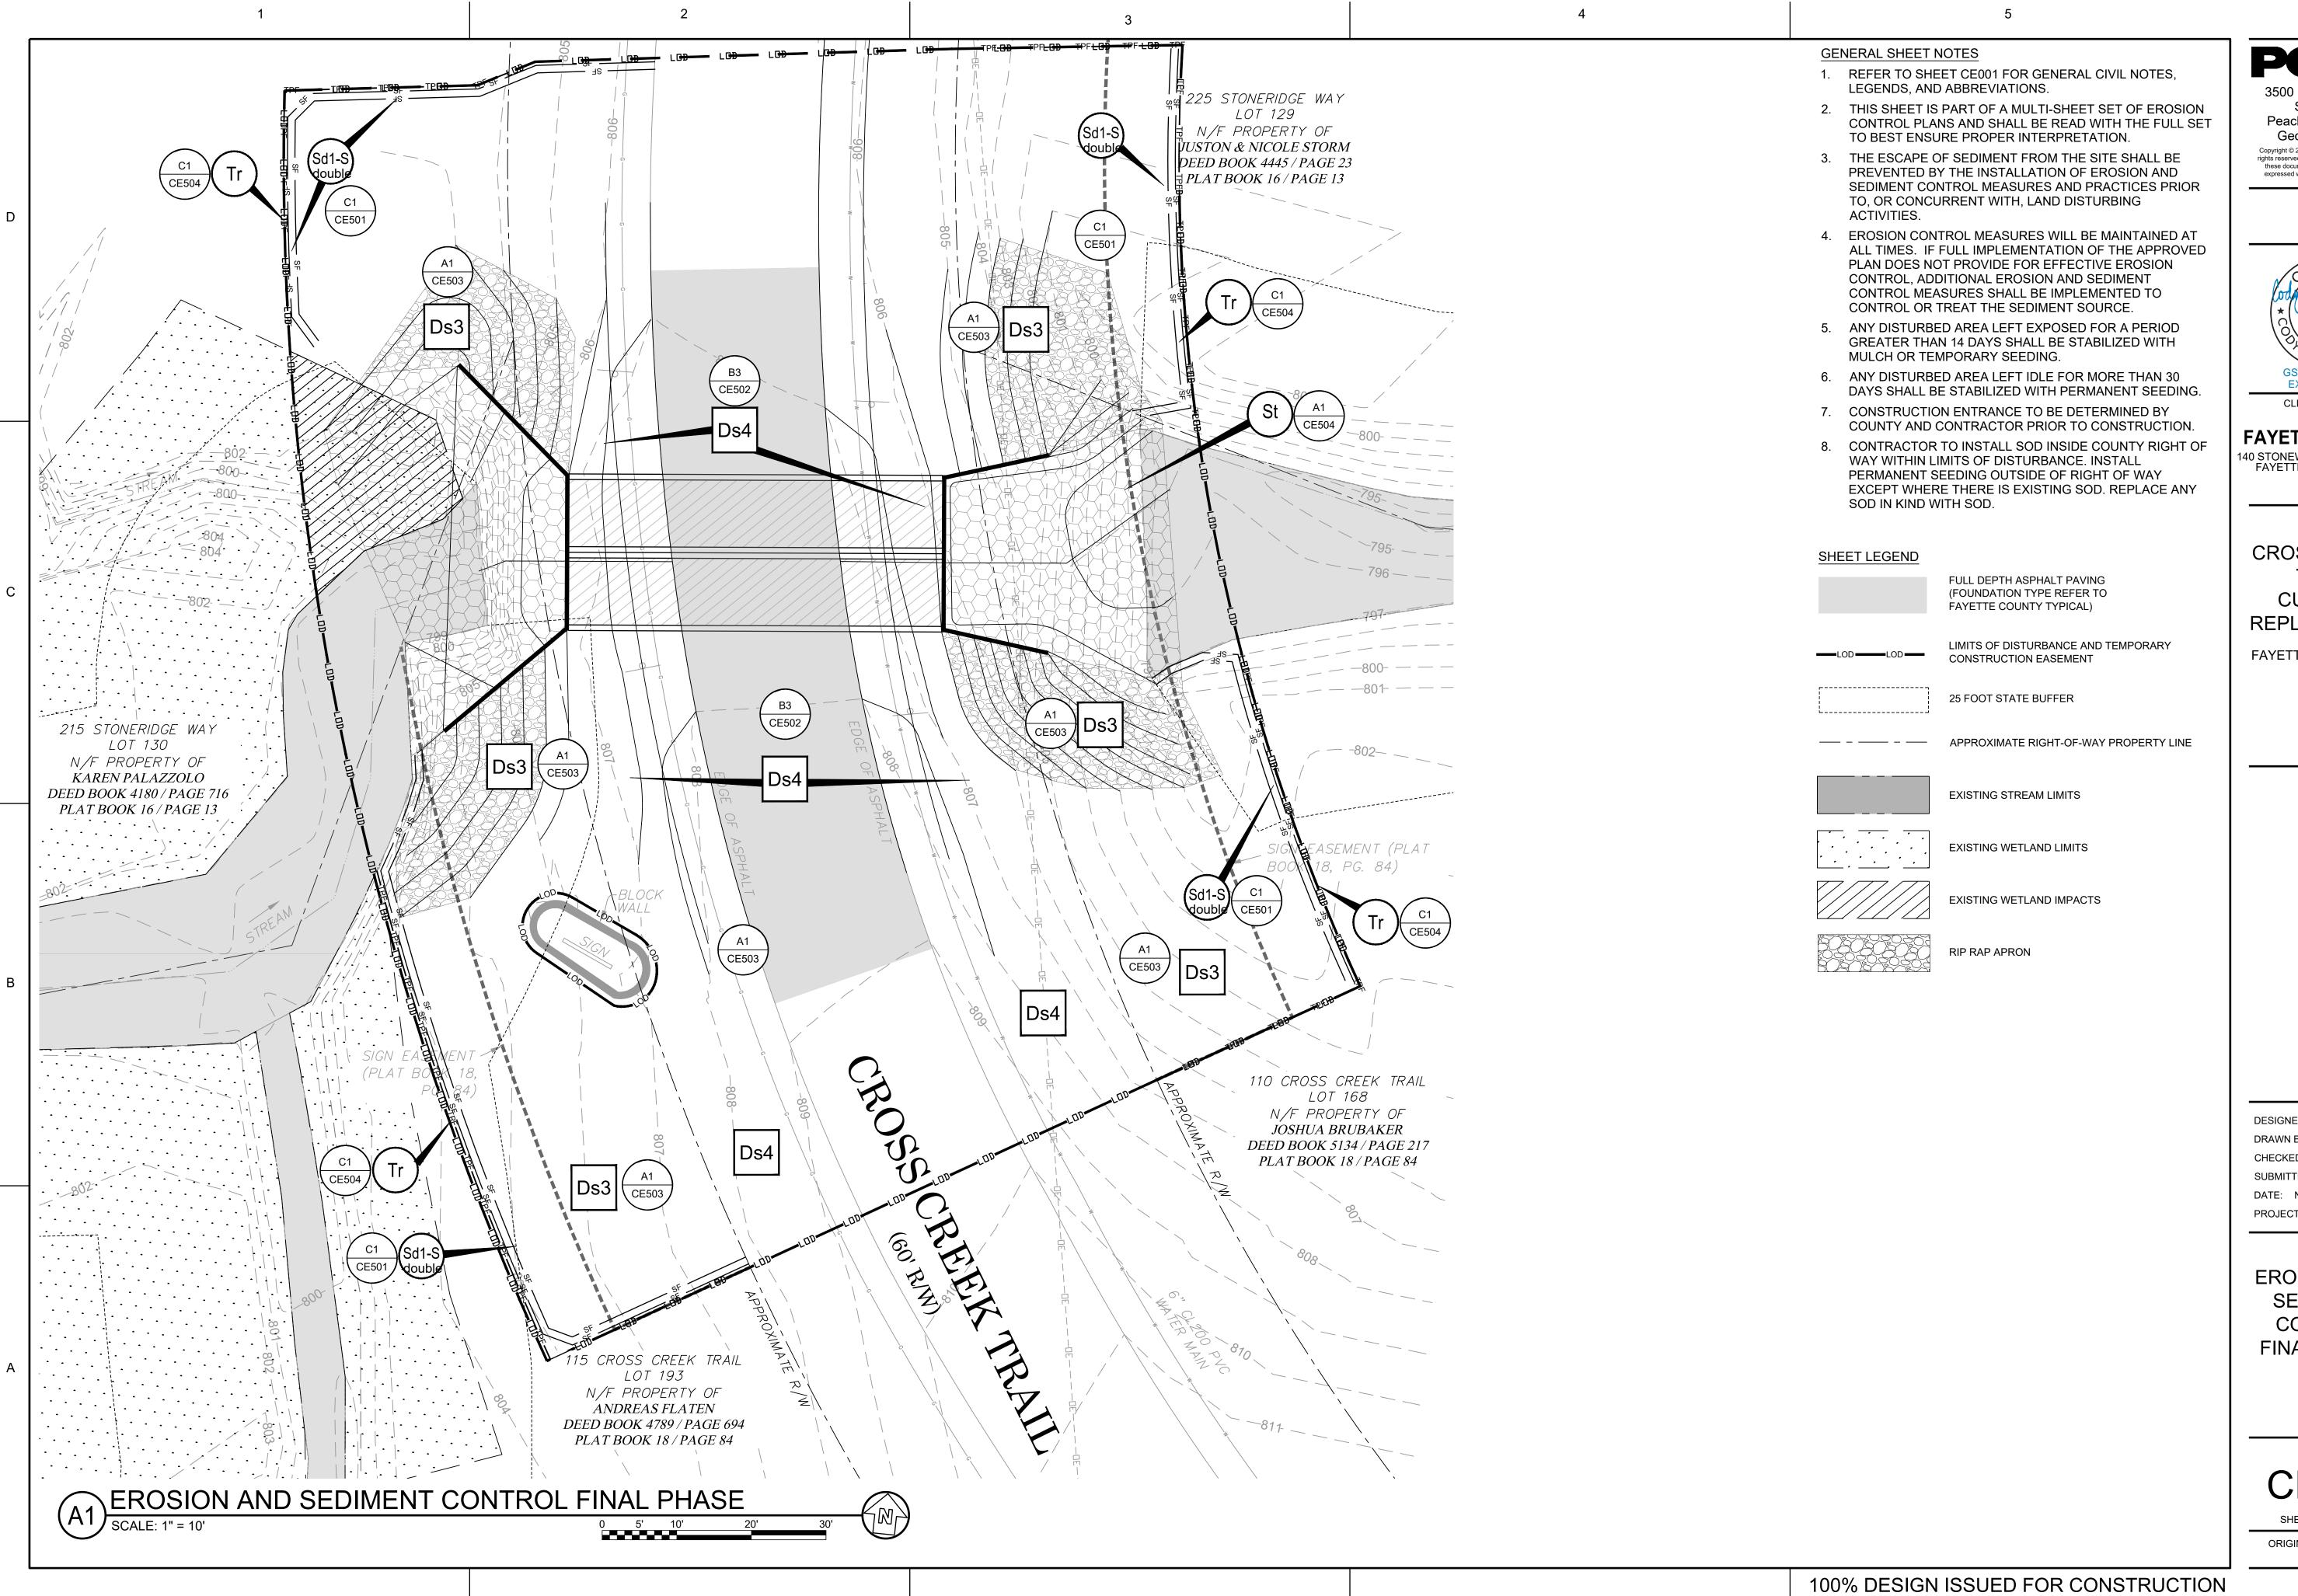

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No. PEO47343

PROFESSIONAL

11/24/2025

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GSWCC# 95439,
EXP. 9/10/2027

CLIENT INFORMATION

FAYETTE COUNTY

140 STONEWALL AVE W, STE 203 FAYETTEVILLE, GA. 30214

PROJECT NAME

CROSS CREEK TRAIL CULVERT REPLACEMENT

FAYETTE COUNTY, GA

DRAWING ISSUE

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DESIGNED BY: MDW/MIA
DRAWN BY: MDW
CHECKED BY: COA
SUBMITTED BY: TT
DATE: NOVEMBER 24, 2025

SHEET TITLE

EROSION AND SEDIMENT CONTROL FINAL PHASE

SHEET NUMBER

CE201

ORIGINAL SHEET SIZE: 22" X 34"

MAINTENANCE

С

SEDIMENT SHALL BE REMOVED ONCE IT HAS ACCUMULATED TO ONE-HALF THE ORIGINAL HEIGHT OF THE BARRIER. FILTER FABRIC SHALL BE REPLACED WHENEVER IT HAS DETERIORATED TO SUCH AN EXTENT THAT THE EFFECTIVENESS OF THE FABRIC IS REDUCED (APPROXIMATELY SIX MONTHS). TEMPORARY SEDIMENT BARRIERS SHALL REMAIN IN PLACE UNTIL DISTURBED AREAS HAVE BEÉN PERMANENTLY STABILIZED. ALL SEDIMENT ACCUMULATED AT THE BARRIER SHALL BE REMOVED AND PROPERLY DISPOSED OF BEFORE THE BARRIER IS REMOVED.

- 1. USE STEEL OR WOOD POSTS OR AS SPECIFIED BY THE EROSION, SEDIMENTATION,
- 2. HEIGHT (*) IS TO BE SHOWN ON THE EROSION, SEDIMENTATION, AND POLLUTION





METHODS AND MATERIALS

A. TEMPORARY METHODS

MULCHES SEE MULCHING. SYNTHETIC RESINS MAY BE USED INSTEAD OF ASPHALT TO BIND MULCH MATERIAL.

SPRAY-ON ADHESIVES THESE ARE USED ON MINERALS SOILS. KEEP TRAFFIC OFF THESE AREAS.

<u>SPRINKLING</u>
THE SITE IS SPRINKLED WITH WATER UNTIL THE SURFACE IS WET. REPEAT AS NEEDED. THIS METHOD IS ESPECIALLY EFFECTIVE ON HAUL ROADS AND OTHER TRAFFIC ROUTES.

Α

BARRIERS
SOLID BOARD FENCES, BURLAP FENCES, CRATE WALLS, BALES OF HAY AND SIMILAR MATERIAL CAN BE USED TO CONTROL AIR CURRENTS AND SOIL BLOWING. BARRIERS PLACED AT RIGHT ANGLES TO PREVAILING CURRENTS AT INTERVALS OF ABOUT 15 TIMES THEIR HEIGHT ARE EFFECTIVE IN CONTROLLING WIND EROSION.


B. PERMANENT METHODS

PERMANENT VEGETATION
SEE STANDARD FOR PERMANENT SEEDING, AND PERMANENT STABILIZATION WITH SOD. EXISTING TREES AND LARGE SHRUBS MAY AFFORD VALUABLE PROTECTION IF LEFT IN PLACE.

 $\frac{\text{TOPSOILING}}{\text{THIS ENTAILS COVERING THE SURFACE WITH LESS EROSIVE SOIL MATERIAL.}} \ \text{SEE TOPSOILING}.$

STONE COVER SURFACE WITH CRUSHED STONE OR COARSE GRAVEL.

DUST CONTROL

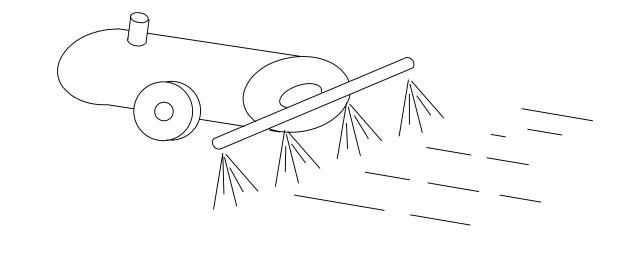

MULCHING MATERIAL

FRONT VIEW

1. DRY STRAW OR HAY SHALL BE APPLIED AT A DEPTH OF 2 TO 4 INCHES PROVIDING COMPLETE SOIL

2. WOOD WASTE (CHIPS, SAWDUST, OR BARK) SHALL BE APPLIED AT A DEPTH OF 2 TO 3 INCHES. ORGANIC MATERIAL FROM THE CLEARING STAGE OF DEVELOPMENT SHOULD REMAIN ON SITE, BE CHIPPED, AND APPLIED

AT 1200 GALLONS PER ACRE (OR 1/4 GALLON PER SQ. 4. POLYETHYLENE FILM SHALL BE SECURED OVER BANKS

OR STOCKPILED SOIL MATERIAL FOR TEMPORARY

3. CUTBACK ASPHALT 9SLOW CURING) SHALL BE APPLIED

PROTECTION. APPLYING MULCH

1. DRY STRAW OR HAY MULCH AND WOOD CHIPS SHALL BE APPLIED UNIFORMLY BY HAND OR BY MECHANICAL

2. IF THE AREA WILL EVENTUALLY BE COVERED WITH PERENNIAL VEGETATION. 20-30 POUNDS OF NITROGEN PER ACRE IN ADDITION TO THE NORMAL AMOUNT SHALL BE APPLIED TO OFFSET THE UPTAKE OF NITROGEN CAUSED BY DECOMPOSITION OF THE ORGANIC MULCHES.

3. CUTBACK ASPHALT SHALL BE APPLIED UNIFORMLY. CARE SHOULD BE TAKEN IN AREAS OF PEDESTRIAN TRAFFIC DUE TO PROBLEMS OF "TRACKING IN" OR DAMAGE TO SHOES, CLOTHING, ETC.

4. APPLY POLYETHYLENE FILM ON EXPOSED AREAS.

ANCHORING MULCH

1. STRAW OR HAY MULCH CAN BE PRESSED INTO THE SOIL WITH A DISK HARROW WITH THE DISK SET STRAIGHT OR WITH A SPECIAL "PACKER DISK." DISKS MAY BE USED SMOOTH OR SERRATED AND SHOULD BE 20 INCHES APART. THE EDGES OF THE DISK SHOULD BE DULL ENOUGH NOT TO CUT THE MULCH BUT TO PRESS IT INTO THE SOIL LEAVING MUCH OF IT IN AN ERECT POSITION. STRAW OF HAY MULCH SHALL BE ANCHORED IMMEDIATELY AFTER APPLICATION.

STRAW OR HAY MULCH SPREAD WITH SPECIAL BLOWER-TYPE EQUIPMENT MAY BE ANCHORED WITH EMULSIFIED ASPHALT (GRADE AE-5 OR SS-1). THE ASPHALT EMULSION SHALL BE SPRAYED ONTO THE MULCH AS IT IS EJECTED FROM THE MACHINE. USE 100 GALLONS OF EMULSIFIED ASPHALT AND 100 GALLONS OF WATER PER TON OF MULCH. TACKIFERS AND BINDERS CAN BE SUBSTITUTED FOR EMULSIFIED ASPHALT. PLEASE REFER TO SPECIFICATION Tb -TACKIFERS AND BINDERS. PLASTIC MESH OR NETTING WITH MESH NO LARGER THAN ONE INCH BY ONE INCH SHALL BE INSTALLED ACCORDING TO MANUFACTURER'S SPECIFICATIONS.

2. NETTING OF THE APPROPRIATE SIZE SHALL BE USED TO ANCHOR WOOD WASTE. OPENING OF THE NETTING SHALL NOT BE LARGER THAN THE AVERAGE SIZE OF THE WOOD WASTE CHIPS.

3. POLYETHYLENE FILM SHALL BE ANCHOR TRENCHED AT THE TOP AS WELL AS INCREMENTALLY AS NECESSARY.

TABLE 1. Mulching Application Requirements

RATE	DEPTH
-	2" to 4"
-	2" to 3"
1200 gal./acre, 1/4 gal./sq. yd./ or see manufacturer's recommendations	-
Secure with soil, anchors, weights	-
See manufacturer's recommendations	-
	- 1200 gal./acre, 1/4 gal./sq. yd./ or see manufacturer's recommendations Secure with soil, anchors, weights See manufacturer's

INSTALLATION NOTES:

1. INSTALL ALL OTHER REQUIRED BMPs FIRST. 2. GRADE SITE. IF POSSIBLE. TO PERMIT THE USE OF EQUIPMENT

- FOR APPLYING AND ANCHORING MULCH.
- 3. LOOSEN COMPACTED SOIL, IF POSSIBLE, TO A DEPTH OF 3
- 4. APPLY STRAW OR HAY UNIFORMLY, AS SHOWN IN TABLE 1, BY HAND OR MECHANICAL EQUIPMENT, AND ANCHOR BY PRESSING INTO SOIL OR USING NETTING.
- 5. MULCH ON SLOPES GREATER THAN 3% SHOULD BE ANCHORED WITH EMULSIFIED ASPHALT (GRADE AE-5 OR SS-1) OR OTHER SUITABLE TACKIFIER.
- 6. WOOD WASTE ON SLOPES FLATTER THAN 3:1 DO NOT NEED ANCHORING.
- 7. MULCH SHALL BE APPLIED TO ALL DISTURBED AREAS LEFT INACTIVE FOR FOURTEEN DAYS.

1. ADD MULCH AS NEEDED TO MAINTAIN THE SUGGESTED DEPTH. 2. IF ORGANIC MULCH IS TO BE LEFT AND INCORPORATED INTO THE SOIL, APPLY 20-30 POUNDS OF NITROGEN IN ADDITION TO THE FERTILIZER REQUIRED FOR VEGETATION.

PROJECT NAME **CROSS CREEK**

TRAIL CULVERT REPLACEMENT

FAYETTE COUNTY, GA

Suite 500 Peachtree Corners

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EXP. 9/10/2027

FAYETTE COUNTY

140 STONEWALL AVE W, STE 203

FAYETTEVILLE, GA. 30214

CLIENT INFORMATION

DRAWING ISSUE

MDW/MIA DESIGNED BY: DRAWN BY: CHECKED BY: SUBMITTED BY: DATE: NOVEMBER 24, 2025 PROJECT#

SHEET TITLE

EROSION AND SEDIMENT CONTROL **DETAILS**

SHEET NUMBER

SHEET 14 OF 20

ORIGINAL SHEET SIZE: 22" X 34"

DISTURBED AREA STABILIZATION (WITH MULCHING ONLY)

Ds1

SEEDBED PREPARATION: WHEN USING CONVENTIONAL OR

PROVIDE A PLACE FOR SEED TO LODGE AND GERMINATE.

INCORPORATED WITH A DISK, RIPPER OR CHISEL.

<u>SEEDING:</u> REFER TO TEMPORARY SEEDING CHART THIS PAGE.

<u>Rates - PLS</u>

Per <u>Acre</u>

3 bu. (144 lbs.)

½ bu. (24 lbs.)

40 lbs.

10 lbs.

2 lbs.

40 lbs.

10 lbs.

50 lbs.

4 bu. (128 lbs.)

1 bu. (32 lbs.)

3 bu. (168 lbs.)

½ bu. (28 lbs.)

40 lbs.

60 lbs.

3 bu. (180 lbs.)

HAND-SEEDING, SEEDBED PREPARATION IS NOT REQUIRED IF THE SOIL MATERIAL IS LOOSE AMD NOT SEALED BY RAINFALL. WHEN SOIL HAS BEEN SEALED BY RAINFALL OR CONSISTS OF SMOOTH UNDISTURBED CUT SLOPES, THE SOIL SHALL HAVE PITTED, TRENCHED OR OTHERWISE SCARIFIED TO

LIME AND FERTILIZER: AGRICULTURAL LIME IS REQUIRED UNLESS SOIL TESTS INDICATE OTHEWRWISE. APPLY AGRICULTURAL LIME AT A RATE OF ONE

TON PER ACRE. GRADED AREAS REQUIRE LIME APPLICATION. SOILS CAN BE TESTED TO SEE IF FERTILIZER IS NEEDED. ON REASONABLY FERTILE SOILS OR SOIL MATERIAL, FERTILIZER IS NOT REQUIRED. FOR SOILS WITH VERY LOW FERTILITY, 500 TO 700 POUNDS OF 10-10-10 FERTILIZER

OF THE EQUIVALENT PER ACRE (12-16 LBS/1000 SQ. FT.) SHALL BE APPLIED. FERTILIZER SHOULD BE APPLIED BEFORE LAND PREPARATION AND

FERTILIZER). DRILL OR CULTIPACKER SEEDERS SHOULD NORMALLY PLACE SEED ONE-QUARTER TO ONE-HALF INCH DEEP. APPROXIMATE DEPTH OF

Planting Dates

(Solid lines indicate optimum

dates, dotted lines indicated

permissible but marginal

APPLY SEED UNIFORMLY BY HAND, CYCLONE SEEDER, DRILL, CULTIPACKER-SEEDER, OR HYDRAULIC SEEDER (SLURRY INCLUDING SEED AND

PLANTING IS TEN TIMES THE SEED DIAMETER. SOIL SHOULD BE RAKED LIGHTLY TO COVER SEED WITH SOIL IF SEEDING BY HAND.

<u>Rates - PLS</u>

Per 1000 <u>sq. ft.</u>

3.3 lb.

0.6 lb.

0.9 lb.

0.2 lb.

0.1 lb.

0.05 lb.

0.9 lb.

0.2 lb.

1.1 lb.

2.9 lb.

0.7 lb.

3.9 lb.

0.6 lb.

0.9 lb.

1.4 lb.

½ bu. (30 lbs.) 0.7 lb.

TEMPORARY SEEDING:

<u>Species</u>

(Hordeum vulgare)

in mixtures

(lezpedeza striata)

in mixtures

LOVEGRASS, WEEPING

(Eragrostis curvula)

in mixtures

MILLET, BROWNTOP

in mixtures

MILLET, PEARL

(Avena sativa)

in mixtures

(Secale cereale)

in mixtures

RYEGRASS, ANNUAL

(Lolium temulentum)

(Sorghum sudanese)

(Triticum aestivum)

alone

В

SUDANGRASS

alone

alone

(Pancium fasciculatum)

(Pennesetum glaucum)

alone

LESPEDEZA,

TABLE 2. FERTILIZER REQUIREMENTS FOR TEMPORARY VEGETATION

Planting Year

First

Second

Maintenance

Maintenance

Second

1. INSTALL ALL E&SC MEASURES PRIOR TO APPLYING TEMPORARY VEGETATION.

FERTILIZER OR EQUIVALENT (12-16 LBS./1000 SQ. FT.)

6 MONTHS, PERMANENT COVER SHALL BE APPLIED.)

FAILS TO EMERGE OR WHERE A POOR STAND EXISTS.

RE-SEED AREAS WHERE AN ADEQUATE STAND OF TEMPORARY VEGETATION

3. SEEDBED PREPARATION IS NOT REQUIRED IF SOIL IS LOOSE AND NOT SEALED BY RAIN.

Types of Species

Cool season grasses

Cool season grasses and

Temporary cover crops

Warm season grasses

TO LODGE AND GERMINATE.

5. AGRICULTURAL LIME IS NOT REQUIRED.

INSTALLATION NOTES:

¼" -½" DEEP.

MAINTENANCE NOTE:

COVER FROM TABLE 1.

seeded alone

Rate (lbs./acre)N Top Dressing Rate (lbs./acre)

50-100

0-50

30

50-100

50-100

1500

1000

400

1500

1000

400

500

1500

800

400

6-12-12

6-12-12

10-10-10

6-12-12

0-10-10

0-10-10

10-10-10

6-12-12

6-12-12

10-10-10

2. GRADING OR SHAPING ARE NOT REQUIRED IF SLOPES CAN BE PLANTED WITH A HYDROSEEDER OR BY HAND-SEEDING.

6. FERTILIZE LOW FERTILITY SOILS PRIOR TO OR DURING PLANTING AT THE RATE OF 500-700 LBS./ACRE OF 10-10-10

8. APPLY SEED BY HAND, CYCLONE SEEDER, DRILL OR HYDRO-SEEDER. SEED PLANTED WITH A DRILL SHOULD BE PLANTED

9. APPLY IN ACCORDANCE WITH SPECIFICATIONS ON THE E&SC PLAN. IF INFORMATION IS NOT AVAILABLE, SELECT A TEMPORARY

10. TEMPORARY COVER SHALL BE APPLIED TO ALL DISTURBED AREAS LEFT IDLE FOR 14 DAYS. (IF AN AREA IS LEFT IDLE FOR

4. WHEN THE SOIL IS SEALED OR CRUSTED, IT SHOULD BE PITTED, TRENCHED OR SCARIFIED TO PROVIDE A PLACE FOR SEED

7. IT IS IMPERATIVE THAT YOU CHECK THE TAG ON THE BAG OF SEED TO VERIFY THE TYPE AND GERMINATION OF THE SEED TO

THIS APPLICATION IS APPROPRIATE FOR AREAS WHICH REQUIRE IMMEDIATE VEGETATIVE

PLANNING CONSIDERATIONS

THE INCREASED INITIAL COSTS.

CAN BE ESTABLISHED NEARLY YEAR-ROUND.

SODDING IS PREFERABLE TO SEED IN WATERWAYS AND SWALES BECAUSE OF THE IMMEDIATE PROTECTION OF THE CHANNEL AFTER APPLICATION. SODDING MUST BE STAKED IN CONCENTRATED FLOW AREAS (SEE FIGURE 6-6.1) CONSIDER USING SOD FRAMED

CONSTRUCTION SPECIFICATIONS INSTALLATION

SOIL PREPARATION

BRING SOIL SURFACE TO FINAL GRADE. CLEAR SURFACE OF TRASH, WOODY DEBRIS, STONES AND CLODS LARGER THAN 1". APPLY SOD TO SOIL SURFACES ONLY AND NOT FROZEN SURFACES, OR GRAVEL TYPE SOILS.TOPSOIL PROPERLY APPLIED WILL HELP GUARANTEE A STAND. DON'T USE TOPSOIL RECENTLY TREATED WITH HERBICIDES OR SOIL STERILANTS. MIX FERTILIZER INTO SOIL SURFACE. FERTILIZE BASED ON SOIL TESTS OR

<u>INSTALLATION</u>

LAY SOD WITH TIGHT JOINTS AND IN STRAIGHT LINES. DON'T OVERLAP JOINTS. STAGGER JOINTS AND DO NOT STRETCH SOD (SEE FIGURE 6-6.2) ON SLOPES STEEPER THAN 3:1, SOD SHOULD BE ANCHORED WITH PINS OR OTHER APPROVED METHODS. INSTALLED SOD SHOULD BE ROLLED OR TAMPED TO PROVIDE GOOD CONTACT BETWEEN SOD AND SOIL. IRRIGATE SOD AND SOIL TO A DEPTH OF 4" IMMEDIATELY AFTER INSTALLATION. SOD SHOULD NOT BE CUT OR SPREAD IN EXTREMELY WET OR DRY WEATHER. IRRIGATION SHOULD BE USED TO SUPPLEMENT RAINFALL FOR A MINIMUM OF 2-3 WEEKS.

PROJECT IS DESIRABLE.

- NOT INCLUDING SHOOTS OR THATCH.
- SOD SHOULD BE CUT TO THE DESIRED SIZE WITHIN + OR -5% TORN OR UNEVEN
- SOD SHOULD BE CUT AND INSTALLED WITHIN 36 HOURS OF DIGGING. 4. AVOID PLANTING WHEN SUBJECT TO FROST HEAVE OR HOT WEATHER IF
- THE SOD TYPE SHOULD BE SHOWN ON THE PLANS OR INSTALLED ACCORDING TO

TABLE 6-6.2. SEE FIGURE 6-4.1 FOR YOUR RESOURCE AREA.


MAINTENANCE

(B3) STABILIZATION W/ SODDING

FERTILIZER REQUIREMENTS FOR SOIL SURFACE APPLICATION

FERTILIZER TYPE	FERTILIZER RATE (lbs/acre)	FERTILIZER RATE (lbs/sq_ft)	SEASO
10-10-10	1000	.025	FAL

AGRICULTURAL LIME SHOULD BE APPLIED BASED ON SOIL TESTS OR AT A RATE OF 1 TO 2 TONS PER ACRE.

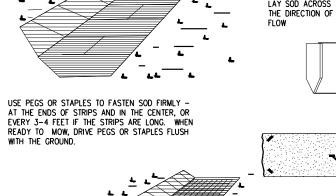



SOD PLANTING REQUIREMENTS

GRASS	VARIETIES	RESOURCE AREA	GROWING SEASON
BERMUDAGRASS	COMMON TIFWAY TIFGREEN TIFLAWN	M-L,P,C P,C P,C P,C	WARM WEATHER
BAHIAGRASS	PENSACOLA	P,C	WARM WEATHER
CENTIPEDE	-	P,C	WARM WEATHER
ST. AUGUSTINE	COMMON BITTERBLUE RALEIGH	С	WARM WEATHER
ZOYSIA	EMERALD MEYER	P,C	WARM WEATHER
TALL FESCUE	KENTUCKY	M-L,P	COOL WEATHER

TABLE 6-6.3 FERTILIZER REQUIREMENTS FOR SOD

	FERTILIZE	K KEQUIKEMEN 15	FUR SUD	
TYPES OF SPECIES	PLANTING YEAR	FERTILIZER (N-P-K)	RATE (lbs./acre)	NITROGEN TOP DRESSING RATE (lbs./acre)
COOL	FIRST	6-12-12	1500	50-100
SEASON	SECOND	6-12-12	1000	
GRASSES	MAINTENANCE	10-10-10	400	30
WARM	FIRST	6-12-12	1500	50-100
SEASON	SECOND	6-12-12	800	50-100
GRASSES	MAINTENANCE	10-10-10	400	30

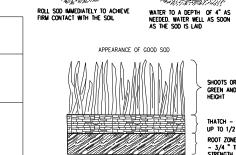

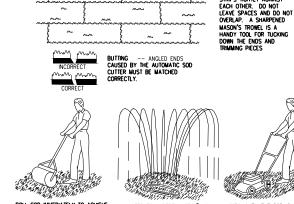

WATER TO A DEPTH OF 4" AS NEEDED, WATER WELL AS SOON AS THE SOD IS LAID

Suite 500

Peachtree Corners

Georgia 30092

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EXP. 9/10/2027

FAYETTE COUNTY

140 STONEWALL AVE W, STE 203

FAYETTEVILLE, GA. 30214

CROSS CREEK

TRAIL

CULVERT

REPLACEMENT

FAYETTE COUNTY, GA

PROJECT NAME

DRAWING ISSUE

CLIENT INFORMATION

ERODED LANDS. CONDITIONS

COVERS, DROP INLETS, GRASS SWALES, AND WATERWAYS WITH INTERMITTENT FLOW.

SODDING CAN INITIALLY BE MORE COSTLY THAN SEEDING, BUT THE ADVANTAGES JUSTIFY

IMMEDIATE EROSION CONTROL, GREEN SURFACE, AND QUICK USE. REDUCED FAILURE AS COMPARED TO SEED AS WELL AS THE LACK OF WEEDS

AROUND DROP INLETS TO REDUCE SEDIMENTS AND MAINTAINING THE GRADE.

MATERIALS

SOD SELECTED SHOULD BE CERTIFIED. SOD GROWN IN THE GENERAL AREA OF THE

- SOD SHOULD BE MACHINE CUT AND CONTAIN 3/4" (+ OR 1/4") OF SOIL,
- PADS SHOULD BE REJECTED.
- IRRIGATION IS NOT AVAILABLE

RE-SOD AREAS WHERE AN ADEQUATE STAND OF SOD IS NOT OBTAINED. NEW SOD SHOULD BE MOWED SPARINGLY. GRASS HEIGHT SHOULD NOT BE CUT LESS THAN 2"-3" OR AS SPECIFIED (SEE FIGURE 6-6.2). APPLY ONE TON OF AGRICULTURAL LIME AS INDICATED BY SOIL TEST OR EVERY 4-6 YEARS. FERTILIZE GRASSES IN ACCORDANCE WITH SOIL TESTS OR TABLE 6-6.3

DISTURBED AREA

TABLE 1. SOME TEMPORARY PLANT SPECIES, SEEDING RATES AND PLANTING DATES

Species	Rates per 1,000 sq. ft.	Rates per Acre	Region M—L (Mountain, Blue Ridge, Ridges and Valley)	Region P (Southern Piedmont	Region C (Southern Coastal Plain, Sand Hills, Black Lands and Atlantic Coastal Flatwoods)
Barley alone	3.3 lbs.	3 bu.			
Barley, in mixtures	0.6 lbs.	0.5 bu.	9 Sept. – 31 Oct.	15 Sept. – 15 Nov.	1 Oct. – 31 Dec.
Lespedeza, Annual	0.9 lbs.	40 lbs.	4 14 74 14	4 14 74 14	4.5.100.5.1
Lespedeza, in mixtures	0.2 lbs.	10 lbs.	1 Mar. — 31 Mar.	1 Mar. — 31 Mar.	1 Feb. – 28 Feb.
Lovegrass, weeping	0.1 lbs.	4 lbs.			
Lovegrass, in mixtures	0.05 lbs.	2 lbs.	1 Apr. – 31 May	1 Apr. – 31 May	1 Mar. – 31 May
Millet, browntop	0.9 lbs.	40 lbs.			
Millet, in mixtures	0.2 lbs.	10 lbs.	15 Apr. – 15 Jun.	15 Apr. – 30 Jun.	15 Apr. – 30 Jun.
Millet, pearl	1.1 lbs.	50 lbs.	15 May — 15 Jul.	1 May — 31 Jul.	15 Apr. – 15 Aug.
Oats, alone	2.99 lbs.	4 bu.	45.0 45.11	45.0 45.11	45.0 1 45.11
Oats, in mixtures	0.7 lbs.	1 bu.	15 Sept. – 15 Nov.	15 Sept. – 15 Nov.	15 Sept. – 15 Nov.
Rye (grain), alone	3.9 lbs.	3 bu.			
Rye, in mixtures	0.6 lbs.	0.5 bu.	15 Aug. – 31 Oct.	15 Sept. – 30 Nov.	1 Oct. – 31 Dec.
Ryegrass	0.9 lbs.	40 lbs.	15 Aug. – 15 Nov.	1 Sept. – 15 Dec.	15 Sept 31 Dec.
Sudangrass	1.4 lbs.	60 lbs.	1 May - 31 Jul.	1 May – 31 Jul.	1 Apr. – 31 Jul.
Triticale, alone	3.3 lbs.	3 bu.			
Triticale, in mixtures	0.6 lbs.	0.5 bu.	-	_	15 Oct. – 30 Nov.
Wheat, alone	4.1 lbs.	3 bu.			
Wheat, in mixtures	0.7 lbs.	0.5 bu.	15 Sept. – 30 Nov.	1 Oct. – 15 Dec.	15 Oct 31 Dec.

1. UNUSUAL SITE CONDITIONS MAY REQUIRE HEAVIEW SEEDING RATES.

2. SEEDING DATES MAY NEED TO BE ALTERED TO FIT TEMPERATURE VARIATIONS AND LOCAL CONDITIONS.

3. FOR MAJOR LAND RESOURCE AREAS (MLRAS), SEE "TACKIFIERS AND BINDERS" OF THE MANUAL FOR EROSION AND SEDIMENT CONTROL IN GEORGIA, LATEST EDITION.

3. SEEDING RATES ARE BASED ON PURE LIVE SEED (PLS).

SEEDING SCHEDULE TEMPORARY COVER

DESIGN PROFESSIONAL: CODY OWENBY, P.E. LEVEL II CERTIFICATION No.: 0000095439 EXPIRES: 09/10/2027



Know what's **below**. before you dig. Dial 811 Or Call 800-282-7411

SHEET NUMBER

CE502

DESIGNED BY:

DATE: NOVEMBER 24, 2025

EROSION AND

SEDIMENT

CONTROL

DETAILS

SHEET TITLE

DRAWN BY: CHECKED BY: SUBMITTED BY:

PROJECT#

SHEET 15 OF 20 ORIGINAL SHEET SIZE:

THIS PRACTICE SHALL BE APPLIED IMMEDIATELY TO ROUGH GRADED AREAS THAT WILL BE LINDISTURBED FOR LONGER THAN SIX MONTHS. THIS PRACTICE OR SODDING SHALL BE APPLIED IMMEDIATELY TO ALL AREAS AT FINAL GRADE. FINAL STABILIZATION MEANS THAT ALL SOIL DISTURBING ACTIVITIES AT THE SITE HAVE BEEN COMPLETED, AND THAT FOR UNPAVED AREAS AND AREAS NOT COVERED BY PERMANENT STRUCTURES. AT LEAST 70% OF THE SOIL SURFACE IS UNIFORMLY COVERED IN PERMANENT VEGETATION OR EQUIVALENT PERMANENT STABILIZATION MEASURES (SUCH AS THE USE OF RIP RAP, GABIONS, PERMANENT MULCHES OR GEOTEXTILES) HAVE BEEN EMPLOYED. PERMANENT VEGETATION SHALL CONSIST OF: PLANTED TREES, SHRUBS, PERENNIAL VINES: A CROP OF PERENNIAL VEGETATION APPROPRIATE FOR THE REGION, SUCH THAT WITHIN THE GROWING SEASON A 70% COVERAGE BY PERENNIAL VEGETATION SHALL BE

STABILIZATION. PERMANENT PERENNIAL VEGETATION SHALL BE USED TO ACHIEVE

GRASSES, OR LEGUMES ON EXPOSED AREAS FOR FINAL PERMANENT

FINAL STABILIZATION APPLIES TO EACH PHASE OF CONSTRUCTION. FOR LINEAR CONSTRUCTION PROJECTS ON LAND USED FOR AGRICULTURAL OR SILVICULTURAL PURPOSES, FINAL STABILIZATION MAY BE ACCOMPLISHED BY STABILIZING THE DISTURBED LAND FOR ITS AGRICULTURAL OR SILVICULTURAL LISE LINTIL THIS STANDARD IS SATISFIED AND PERMANENT CONTROL MEASURES. AND FACILITIES ARE OPERATIONAL. INTERIM STABILIZATION MEASURES AND TEMPORARY EROSION AND SEDIMENTATION CONTROL MEASURES SHALL NOT BE

PLANNING CONSIDERATIONS

- USE CONVENTIONAL PLANTING METHODS WHERE POSSIBLE. 2. WHEN MIXED PLANTINGS ARE DONE DURING MARGINAL PLANTING PERIODS,
- COMPANION CROPS SHALL BE USED. NO-TILL PLANTING IS EFFECTIVE WHEN PLANTING IS DONE FOLLOWING A SUMMER OR WINTER ANNUAL COVER CROP.
- 4. BLOCK SOD PROVIDES IMMEDIATE COVER. IT IS ESPECIALLY EFFECTIVE IN CONTROLLING EROSION ADJACENT TO CONCRETE FLUMES AND OTHER STRUCTURES REFER TO Ds-4 DISTURBED AREA STABILIZATION (WITH SODDING)
- 5. IRRIGATION SHOULD BE USED WHEN THE SOIL IS DRY OR WHEN SUMMER PLANTINGS ARE DONE.
- 6. LOW MAINTENANCE PLANTS, AS WELL AS NATIVES, SHOULD BE USED TO ENSURE LONG LASTING EROSION CONTROL. 7. MOWING SHOULD NOT BE PERFORMED DURING THE QUAIL NESTING SEASON (MAY TO SEPT.) WILDLIFE PLANTINGS SHOULD BE INCLUDED IN CRITICAL AREA PLANTINGS. SEE MANUAL FOR PLANT LIST.

GRADING & SHAPING

GRADING AND SHAPING MAY NOT BE REQUIRED WHERE HYDRAULIC SEEDING AND FERTILIZING EQUIPMENT IS TO BE USED, VERTICAL BANKS SHALL BE SLOPED TO ENABLE PLANT ESTABLISHMENT. WHEN CONVENTIONAL SEEDING AND FERTILIZING ARE TO BE DONE, GRADE AND SHAPE WHERE FEASIBLE AND PRACTICAL SO THAT EQUIPMENT CAN BE USED SAFELY AND EFFICIENTLY DURING SEEDBED PREPARATION, SEEDING, MULCHING AND MAINTENANCE OF THE VEGETATION. CONCENTRATIONS OF WATER THAT WILL CAUSE EXCESSIVE SOIL EROSION SHALL BE DIVERTED TO A SAFE OUTLET. DIVERSIONS AND OTHER TREATMENT PRACTICES SHALL CONFORM WITH THE APPROPRIATE STANDARDS AND SPECIFICATIONS.

LIME AND FERTILIZER APPLICATION

HOLE BESIDE EACH TREE SEEDLING

SPECIES

BAHIA, PENSACOLA

ALONE OR WITH

WITH OTHER

PERENNIALS

(PASPALUM NOTATUM)

TEMPORARY COVER

BAHIA, WILMINGTON (PASPALUM NOTATUM)

TEMPORARY COVER

BERMUDA, COMMON

WITH OTHER

PERENNIALS

BERMUDA, COMMON

UNHULLED SEED

(CYNODON DACTYLON)

WITH TEMPORARY COVER

(CYNODON DACTYLON)

COASTAL, COMMON,

MIDLAND, OR TIFT 44

COASTAL, COMMON

OR TIFT 44

TIFT 78

CENTIPEDE

(ERMOCHLO) OPHIUROIDES)

(CYNODON DACTYLON)

WITH OTHER PERENNIALS

ALONE OR WITH

WHEN HYDRAULIC SEEDING EQUIPMENT IS USED, THE INITIAL FERTILIZER SHALL BE MIXED WITH SEED, INNOCULANT (IF NEEDED), AND WOOD CELLULOSE OR WOOD PULP FIBER MULCH AND APPLIED IN A SLURRY. THE INNOCULANT, IF NEEDED, SHALL BE MIXED WITH THE SEED PRIOR TO BEING PLACED INTO THE HYDRAULIC SEEDER. THE SLURRY MIXTURE WILL BE AGITATED DURING APPLICATION TO KEEP THE INGREDIENTS THOROUGHLY MIXED. THE MIXTURE WILL BE SPREAD UNIFORMLY OVER THE AREA WITHIN ONE HOUR AFTER BEING PLACED IN THE HYDROSEEDER.

- FINELY GROUND LIMESTONE WILL BE MIXED WITH WATER AND APPLIED IMMEDIATELY AFTER MULCHING IS COMPLETED OR IN COMBINATION WITH THE TOP DRESSING. WHEN CONVENTIONAL PLANTING IS TO BE DONE, LIME AND FERTILIZER SHALL BE APPLIED UNIFORMLY IN ONE OF THE FOLLOWING WAYS. 1. APPLY BEFORE LAND PREPARATION SO THAT IT WILL BE MIXED WITH THE SOIL
- DURING SEEDBED PREPARATION. 2. MIX WITH THE SOIL USED TO FILL THE HOLES, DISTRIBUTE IN FURROWS. 3. BROADCAST AFTER STEEP SURFACES ARE SCARIFIED, PITTED OR TRENCHED. 4. A FERTILIZER PELLET SHALL BE PLACED AT ROOT DEPTH IN THE CLOSING

PER 1000 sq. ft.

60 LBS 1.4 LB

30 LBS 0.7 LB

60 LBS 1.4 LB

30 LBS 0.7 LB

10 LBS 0.2 LB

6 LBS 0.1 LB

10 LBS 0.2 LB

SOD PLUGS 3' X 3'

0.9 CU. FT.

40 CU. FT

RESOURCE

AREA 3/

BROADCAST

RATES 1/ - PLS 2/

PER ACRE

LIME AND FERTILIZER RATES AND ANALYSIS

AGRICULTURAL LIME IS REQUIRED AT A RATE OF ONE TO TWO TONS PER ACRE UNLESS SOIL TESTS INDICATE OTHERWISE. GRADED AREAS REQUIRE LIME APPLICATION. IF LIME IS APPLIED WITHIN SIX MONTHS OF PLANTING PERMANENT PERENNIAL VEGETATION, ADDITIONAL LIME IS NOT REQUIRED. AGRICULTURAL LIME SHALL BE WITHIN THE SPECIFICATIONS OF THE GEORGIA DEPARTMENT OF

LIME SPREAD BY CONVENTIONAL EQUIPMENT SHALL BE "GROUND LIMESTONE." GROUND LIMESTONE IS CALCITIC OR DOLOMITIC LIMESTONE GROUND SO THAT 90% OF THE MATERIAL WILL PASS THROUGH A 10-MESH SIEVE, NOT LESS THAN 50% WILL PASS THROUGH A 50-MESH SIEVE AND NOT LESS THAN 25 PERCENT WILL PASS THROUGH A 100-MESH SIEVE.

AGRICULTURAL LIME SPREAD BY HYDRAULIC SEEDING EQUIPMENT SHALL BE "FINELY GROUND LIMESTONE." FINELY GROUND LIMESTONE IS CALCITIC OR DOLOMITIC LIMESTONE GROUND SO THAT 98% OF THE MATERIAL WILL PASS THROUGH A 20-MESH SIEVE AND NOT LESS THAN 70% WILL PASS THROUGH A

IT IS DESIRABLE TO USE DOLOMITIC LIMESTONE IN THE SAND HILLS, SOUTHERN COASTAL PLAIN AND ATLANTIC COAST FLATWOODS MLRA'S. (SEE MANUAL). AGRICULTURAL LIME IS GENERALLY NOT REQUIRED WHERE ONLY TREES ARE PLANTED. INITIAL FERTILIZATION, NITROGEN, TOPDRESSING, AND MAINTENANCE FERTILIZER REQUIREMENTS FOR EACH SPECIES OR COMBINATION OF SPECIES ARE LISTED IN TABLE 6-5.1. PLANT SELECTION

REFER TO TABLES 6-4.1, 6-5.2, 6-5.3 AND 6-5.4 FOR APPROVED SPECIES. SPECIES NOT LISTED SHALL BE APPROVED BY THE STATE RESOURCE CONSERVATIONIST OF THE NATURAL RESOURCE CONSERVATION SERVICE BEFORE THEY ARE USED. PLANTS SHALL BE SELECTED ON THE BASIS OF SPECIES CHARACTERISTICS. SITE AND SOIL CONDITIONS, PLANNED USE AND MAINTENANCE OF THE AREA; TIME OF YEAR OF PLANTING, METHOD OF PLANTING; AND THE NEEDS AND DESIRES OF THE LAND USER. SOME PERENNIAL SPECIES ARE EASILY ESTABLISHED AND CAN BE PLANTED ALONE. EXAMPLES OF THESE ARE COMMON BERMUDA, TALL FESCUE AND WEEPING LOVEGRASS. OTHER PERENNIALS SUCH AS BAHIA GRASS AND SERICEA LESPEDEZA ARE SLOW TO BECOME ESTABLISHED AND SHOULD BE PLANTED WITH ANOTHER PERENNIAL SPECIES. THE ADDITIONAL SPECIES WILL PROVIDE QUICK COVER AND AMPLE SOIL PROTECTION UNTIL THE TARGET PERENNIAL SPECIES BECOME ESTABLISHED. FOR EXAMPLE COMMON SEEDING COMBINATIONS INCLUDE: WEEPING LOVEGRASS WITH SERICEA LESPEDEZA (SCARIFIED) AND TALL FESCUE WITH SERICEA LESPEDEZA (UNSCARIFIED).

PLANT SELECTION MAY ALSO INCLUDE ANNUAL COMPANION CROPS ANNUAL COMPANION CROPS SHOULD BE USED ONLY WHEN THE PERENNIAL SPECIES ARE NOT PLANTED DURING THEIR OPTIMUM PLANTING PERIOD. A COMMON MIXTURE IS BROWN TOP MILLET WITH COMMON BERMUDA IN MID-SUMMER. CARE SHOULD BE TAKEN IN SELECTING COMPANION CROP SPECIES AND SEEDING RATES BECAUSE ANNUAL CROPS WILL COMPETE WITH PERENNIAL SPECIES FOR WATER. NUTRIENTS AND GROWING SPACE. A HIGH SEEDING RATE OF THE COMPANION CROP MAY PREVENT THE ESTABLISHMENT OF PERENNIAL SPECIES. RYEGRASS SHALL NOT BE USED IN ANY SEEDING MIXTURES CONTAINING PERENNIAL SPECIES DUE TO ITS ABILITY TO OUT-COMPETE DESIRED SPECIES CHOSEN FOR PERMANENT PERENNIAL COVER.

THE TERM "PURE LIVE SEED" IS USED TO EXPRESS THE QUALITY OF SEED AND IS NOT SHOWN ON THE LABEL. PURE LIVE SEED. PLS. IS EXPRESSED AS A PERCENTAGE OF THE SEEDS THAT ARE PURE AND WILL GERMINATE. INFORMATION ON PERCENT GERMINATION AND PURITY CAN BE FOUND ON SEED TAGS. PLS IS DETERMINED BY MULTIPLYING THE PERCENT OF PURE SEED WITH THE PERCENT OF GERMINATION; I.E., PLS = % GERMINATION x % PURITY

THE PERCENT OF PLS HELPS YOU DETERMINE THE AMOUNT OF SEED YOU NEED. FOR EXAMPLE IF THE SEEDING RATE IS 10 POUNDS PLS AND THE BULK SEED IS

THE BULK SEEDING RATE IS: 10 LBS. OF PLS / ACRE = 17.9 LBS / ACRE

REMARKS

166,000 SEED PER POUND, LOW

GROWING, SOD FORMING

WITH A COMPANION CROP

WEEPING LOVEGRASS.

SAME AS ABOVE

QUICK COVER. LOW

GROWING AND SOD

FOR ATHLETIC FIELDS

PLANT WITH WINTER

PLANT WITH TALL

ANNUALS.

1.787.000 SEED PER POUND

FORMING. FULL SUN. GOOD

SLOW TO ESTABLISH, PLANT

WILL SPREAD INTO BERMUDA

PASTURES AND LAWNS. MIX

WITH SERICEA LESPEDEZA OR

YOU WOULD NEED TO PLANT 17.9 LBS/ACRE TO PROVIDE 10 LBS/ACRE OF PURE

SEEDBED PREPARATION MAY NOT BE REQUIRED WHERE HYDRAULIC SEEDING AND FERTILIZING EQUIPMENT IS TO BE USED. WHEN CONVENTIONAL SEEDING IS TO BE USED, SEEDBED PREPARATION WILL BE DONE AS FOLLOWS:

1. TILLAGE AT A MINIMUM, SHALL ADEQUATELY LOOSEN THE SOIL TO A DEPTH OF 4 TO 6 IN. ALLEVIATE COMPACTION; INCORPORATE LIME AND FERTILIZER; SMOOTH AND FIRM THE SOIL; ALLOW FOR THE PROPER PLACEMENT OF SEED, SPRIGS, OR PLANTS; AND ALLOW FOR THE ANCHORING OF STRAW OR HAY MULCH IF A DISK IS TO BE USED.

2 TILLAGE MAY BE DONE WITH ANY SUITABLE FOLIPMENT 3. TILLAGE SHOULD BE DONE ON THE CONTOUR, WHERE FEASIBLE.

4. ON SLOPES TOO STEEP FOR THE SAFE OPERATION OF TILLAGE EQUIPMENT THE SOIL SURFACE SHALL BE PITTED OR TRENCHED ACROSS THE SLOPE WITH APPROPRIATE HAND TOOLS TO PROVIDE TWO PLACES 6 TO 8 IN APART IN WHICH SEED MAY LODGE AND GERMINATE. HYDRAULIC SEEDING MAY ALSO

INDIVIDUAL PLANTS

- 1. WHERE INDIVIDUAL PLANTS ARE TO BE SET, THE SOIL SHALL BE PREPARED BY EXCAVATING HOLES, OPENING FURROWS, OR DIBBLE PLANTING.
- 2. FOR NURSERY STOCK PLANTS, HOLES SHALL BE LARGE ENOUGH TO
- ACCOMMODATE ROOTS WITHOUT CROWDING
- 3. WHERE PINE SEEDLINGS ARE TO BE PLANTED, SUBSOIL UNDER THE ROW 36 INCHES DEEP ON THE CONTOUR FOUR TO SIX MONTHS PRIOR TO PLANTING. SUBSOILING SHOULD BE DONE WHEN THE SOIL IS DRY, PREFERABLY IN AUGUST OR SEPTEMBER.

INNOCULANTS ALL LEGUME SEED SHALL BE INOCULATED WITH APPROPRIATE NITROGEN-FIXING BACTERIA. THE INNOCULANT SHALL BE A PURE CULTURE PREPARED SPECIFICALLY FOR THE SEED SPECIES AND USED WITHIN THE DATES ON THE CONTAINER. A MIXING MEDIUM RECOMMENDED BY THE MANUFACTURER SHALL BE USED TO BOND THE INNOCULANT TO THE SEED. FOR CONVENTIONAL SEEDING, USE TWICE THE AMOUNT OF INNOCULANT RECOMMENDED BY THE MANUFACTURER. FOR HYDRAULIC SEEDING, FOUR TIMES THE AMOUNT OF INNOCULANT RECOMMENDED BY THE MANUFACTURER SHALL BE USED. ALL INOCULATED SEED SHALL BE PROTECTED FROM THE SUN AND HIGH TEMPERATURES AND SHALL BE PLANTED THE SAME DAY INOCULATED. NO INOCULATED SEED SHALL REMAIN IN THE HYDROSEEDER LONGER THAN ONE

BROADCAST

RATES 1/ - PLS 2/

15 LBS 0.3 LB

50 LBS. 1.1 LB

30 LBS. 0.7 LB

3' - 7'- APART

60 LBS.

75 LBS.

3 TONS

1.4 LE

1.7 LB

138 LBS

1000

PER ACRE

SPECIES

CROWNVETCH

FESCUE, TALL

ALONE

PERENNIALS

KUDZU

(PUERARIA

CROWNS

THUMBERGIANA)

PLANTS OR

(LESPEDEZA

SCARIFIED

UNSCARIFIED

SEED-BEARING HAY

CUNEATA)

LESPEDEZA SERICEA

ARUNDINACEA)

(FESTUCA

(CORONILLA VARIA)

WITH WINTER

ANNUALS OR

GRASSES

COOL SEASON

AFTER THE MIXTURE IS MADE

HYDRAULIC SEEDING: MIX THE SEED (INOCULATED IF NEEDED), FERTILIZER, AND WOOD CELLULOSE OR WOOD PULP FIBER MULCH WITH WATER AND APPLY IN A SLURRY UNIFORMLY OVER THE AREA TO BE TREATED. APPLY WITHIN ONE HOUR

CONVENTIONAL SEEDING: SEEDING WILL BE DONE ON A FRESHLY PREPARED AND FIRMED SEEDBED. FOR BROADCAST PLANTING, USE A CULTIPACKER-SEEDER, DRILL, ROTARY SEEDER, OTHER MECHANICAL SEEDER, OR HAND SEEDING TO DISTRIBUTE THE SEED UNIFORMLY OVER THE AREA TO BE TREATED. COVER THE SEED LIGHTLY WITH 1/8 TO 1/4 INCH OF SOIL FOR SMALL SEED AND 1/2 TO 1 INCH FOR LARGE SEED WHEN USING A CULTIPACKER OR OTHER SUITABLE EQUIPMENT NO-TILL SEEDING: NO-TILL SEEDING IS PERMISSIBLE INTO ANNUAL COVER CROPS WHEN PLANTING IS DONE FOLLOWING MATURITY OF THE COVER CROP OR IF THE TEMPORARY COVER STAND IS SPARSE ENOUGH TO ALLOW ADEQUATE GROWTH OF THE PERMANENT (PERENNIAL) SPECIES. NO TILL SEEDING SHALL BE DONE WITH APPROPRIATE NO-TILL SEEDING EQUIPMENT. THE SEED MUST BE UNIFORMLY DISTRIBUTED AND PLANTED AT THE PROPER DEPTH. INDIVIDUAL PLANTS: SHRUBS, VINES AND SPRIGS MAY BE PLANTED WITH APPROPRIATE PLANTERS OR HAND TOOLS. PINE TREES SHALL BE PLANTED MANUALLY IN THE SUBSOIL FURROW. EACH PLANT SHALL BE SET IN A MANNER THAT WILL AVOID CROWDING THE ROOTS. NURSERY STOCK PLANTS SHALL BE PLANTED AT THE SAME DEPTH OR SLIGHTLY DEEPER THAN THEY GREW AT THE NURSERY. THE TOPS OF VINES AND SPRIGS MUST BE AT OR SLIGHTLY ABOVE THE GROUND SURFACE. WHERE INDIVIDUAL HOLES ARE DUG, FERTILIZER SHALL BE PLACED IN THE BOTTOM OF THE HOE, TWO INCHES OF SOIL SHALL BE ADDED AND THE PLANT SHALL BE SET IN THE HOLE.

MULCH IS REQUIRED FOR ALL PERMANENT VEGETATION APPLICATIONS. MULCH APPLIED TO SEEDED AREAS SHALL ACHIEVE 75% SOIL COVER. SELECT THE MULCHING MATERIAL FROM THE FOLLOWING AND APPLY AS INDICATED.

DRY STRAW OR DRY HAY OF GOOD QUALITY AND FREE OF WEED SEEDS CAN BE USED, DRY STRAW SHALL BE APPLIED AT THE RATE OF 2 TONS PER ACRE, DRY HAY SHALL BE APPLIED AT A RATE OF 2 1/2 TONES PER ACRE WOOD CELLULOSE MULCH OR WOOD PULP FIBER SHALL BE USED WITH HYDRAULIC SEEDING. IT SHALL BE APPLIED AT THE RATE OF 500 POUNDS PER ACRE. DRY STRAW OR DRY HAY SHALL BE APPLIED (AT THE RATE INDICATED ABOVE) AFTER THE HYDRAULIC SEEDING. ONE THOUSAND POUNDS OF WOOD CELLULOSE OR WOOD PULP FIBER, WHICH

INCLUDES A TACKIFIER, SHALL BE USED WITH HYDRAULIC SEEDING ON SLOPES SERICEA LESPEDEZA HAY CONTAINING MATURE SEED SHALL BE APPLIED AT A RATE OF THREE TONS PER ACRE.

RESOURCE

AREA 3/

PLANTS, PLANTING RATES, AND PLANTING DATES

PLANTING DATES BY RESOURCE AREAS

PLANTING DATES

DOTTED LINES INDICATE PERMISSIBLE BUT

J F M A M J J A S O N D

(SOLID LINES INDICATE OPTIMUM DATES

PINE STRAW OR PINE BARK SHALL BE APPLIED AT A THICKNESS OF 3 INCHES FOR BEDDING PURPOSES OTHER SUITABLE MATERIALS IN SUFFICIENT QUANTITY MAY BE USED WHERE ORNAMENTALS OR OTHER GROUND COVERS ARE PLANTED. THIS IS NOT APPROPRIATE FOR SEEDED AREAS.

WHEN USING TEMPORARY EROSION CONTROL BLANKETS OR BLOCK SOD. MULCH IS NOT REQUIRED. BITUMINOUS TREATED ROVING MAY BE APPLIED ON PLANTED AREAS ON SLOPES. IN DITCHES OR DRY WATERWAYS TO PREVENT EROSION. BITUMINOUS TREATED ROVING SHALL BE APPLIED WITHIN 24 HOURS AFTER AN AREA HAS BEEN PLANTED. APPLICATION RATES AND MATERIALS MUST MEET GEORGIA DEPARTMENT OF TRANSPORTATION SPECIFICATIONS.

WOOD CELLULOSE AND WOOD PULP FIBERS SHALL NOT CONTAIN GERMINATION OR GROWTH INHIBITING FACTORS. THEY SHALL BE EVENLY DISPERSED WHEN AGITATED IN WATER. THE FIBERS SHALL CONTAIN A DYE TO ALLOW VISUAL METERING AND AID IN UNIFORM APPLICATION DURING SEEDING.

TRAW OR HAY MULCH WILL BE SPREAD UNIFORMLY WITHIN 24 HOURS AFTER SEEDING AND/OR PLANTING THE MULCH MAY BE SPREAD BY BLOWER TYPE SPREADING FOUIPMENT OTHER SPREADING FOUIPMENT OR BY HAND, MUI CH SHALL BE APPLIED TO COVER 75% OF THE SOIL SURFACE. WOOD CELLULOSE OR WOOD FIBER MULCH SHALL BE APPLIED UNIFORMLY WITH HYDRAULIC SEEDING EQUIPMENT.

ANCHORING MULCH ANCHOR STRAW OR HAY MULCH IMMEDIATELY AFTER APPLICATION BY ONE OF THE FOLLOWING METHODS .: EMULSIFIED ASPHALT CAN BE (A) SPRAYED UNIFORMLY ONTO THE MULCH AS IT IS EJECTED FROM THE BLOWER MACHINE OR (B) SPRAYED ON THE MULCH IMMEDIATELY FOLLOWING MULCH APPLICATION WHEN STRAW OR HAY IS SPREAD BY METHODS OTHER THAN SPECIAL BLOWER EQUIPMENT. THE COMBINATION OF ASPHALT EMULSION AND WATER SHALL CONSIST OF A HOMOGENEOUS MIXTURE SATISFACTORY FOR SPRAYING. THE MIXTURE SHALI CONSIST OF 100 GALLONS OF WATER PER TON OF MULCH, CARE SHALL BE TAKEN AT ALL TIMES TO PROTECT STATE WATERS, THE PUBLIC, ADJACENT PROPERTY,

PAVEMENTS, CURBS, SIDEWALKS AND OTHER STRUCTURES FROM ASPHALT DISCOLORATION. 2. HAY AND STRAW MULCH SHALL BE PRESSED INTO THE SOIL IMMEDIATELY AFTER THE MULCH IS SPREAD. A SPECIAL "PACKER DISK" OR DISK HARROW WITH THE DISKS SET STRAIGHT MAY BE USED. THE DISKS MAY BE SMOOTH OR SERRATED AND SHOULD BE 20 INCHES OR MORE IN DIAMETER AND 8 TO 12 INCHES APART. THE EDGES OF THE DISKS SHALL BE DULL ENOUGH TO PRESS THE MULCH INTO THE GROUND WITHOUT CUTTING IT, LEAVING MUCH OF IT IN AN ERECT POSITION. MULCH SHALL NOT BE PLOWED INTO THE SOIL. 3. SYNTHETIC TACKIFIERS OR BINDERS APPROVED BY GDOT SHALL BE APPLIED IN CONJUNCTION WITH OR IMMEDIATELY AFTER THE MUI CH IS SPREAD SYNTHETIC TACKIFIERS SHALL BE MIXED AND APPLIED ACCORDING TO MANUFACTURER'S SPECIFICATIONS. REFER TO Tb - TACKIFIERS AND BINDERS. 4 RYE OR WHEAT CAN BE INCLUDED WITH FALL AND WINTER PLANTINGS TO STABILIZE THE MULCH. THEY SHALL BE APPLIED AT A RATE OF ONE-QUARTER TO ONE-HALF BUSHEL PER ACRE. 5. PLASTIC MESH OR NETTING WITH MESH NO LARGER THAN ONE INCH BY ONE INCH MAY BE NEEDED TO ANCHOR STRAW OR HAY MULCH ON UNSTABLE SOILS AND CONCENTRATED FLOW AREAS. THESE MATERIALS SHALL BE INSTALLED AND ANCHORED ACCORDING TO

BEDDING MATERIAL: MULCH USED AS A BEDDING MATERIAL TO CONSERVE MOISTURE AND CONTROL WEEDS IN NURSERIES, ORNAMENTAL BEDS, AROUND SHRUBS, AND ON BARE AREAS ON LAWNS.

GRAIN STRAW 4" TO 6" GRASS HAY PINE NEEDLES 3" TO 5" WOOD WASTE 4" TO 6"

REMARKS

100,000 SEED PER POUND. DENSE

GROWTH, DROUGHT TOLERANT AND

FIRE RESISTANT, ATTRACTIVE ROSE

PINK, AND WHITE BLOSSOMS SPRING

TO LATE FALL. MIX WITH 30 POUNDS OF

TALL FESCUE OR 15 POUNDS OF RYE.

INOCULATE SEED WITH M INNOCULANT

USE FROM NORTH ATLANTA AND

227,000 SEED PER POUND, USE

PERENNIAL LESPEDEZAS OR

IN SPRING FOLLOWING FALL

AREAS OR ATHLETIC FIELDS.

RAPID AND VIGOROUS

WILL CLIMB. GOOD

LIVESTOCK FORAGE.

GROWTH, EXCELLENT IN

GULLY EROSION CONTROL

ALONE ONLY ON BETTER SITES. NOT

CROWNVETCH. APPLY TOPDRESSING

350,000 SEED PER POUND. WIDELY

ADAPTED, LOW MAINTENANCE, MIX

COMMON BERMUDA, BAHIA, OR TAL

FESCUE. TAKES 2 TO 3 YEARS TO

WITH WEEPING LOVEGRASS.

BECOME FULLY ESTABLISHED.

EXCELLENT ON ROADBANKS

INOCULATE SEED WITH EL

MIX WITH TALL FESCUE

OR WINTER ANNUALS.

CUT WHEN SEED IS

MATURE, BUT BEFORE IT

SHATTERS. ADD TALL

FESCUE OR WINTER

ANNUALS.

INNOCULANT.

FOR DROUGHTY SOILS. MIX WITH

PLANTINGS. NOT FOR HEAVY USE

MANUFACTURER'S SPECIFICATIONS.

<u>IRRIGATION</u>: IRRIGATION WILL BE APPLIED AT A RATE THAT WILL NOT CAUSE

TOPDRESSING: WILL BE APPLIED ON ALL TEMPORARY AND PERMANENT PERENNIAL) SPECIES PLANTED ALONE OR IN MIXTURES WITH OTHER SPECIES. RECOMMENDED RATES OF APPLICATION ARE LISTED IN TABLE 6-5.1

SECOND YEAR AND MAINTENANCE FERTILIZATION: SECOND YEAR FERTILIZER RATES AND MAINTENANCE FERTILIZER RATES ARE LISTED IN TABLE 6-5.1

LIME MAINTENANCE APPLICATION: APPLY ONE TON OF AGRICULTURAL LIME EVERY 4 TO 6 YEARS OR AS INDICATED BY SOIL TESTS. SOIL TESTS CAN BE CONDUCTED TO DETERMINE MORE ACCURATE REQUIREMENTS IF DESIRED.

(HELIANTHUS

MAXIMILIANI)

			ANALYSIS OR EQUIVALENT N-P-K		N TOP DRESSING RATE
1.	COOL SEASON GRASSES	FIRST SECOND MAINTENANCE	6-12-12 6-12-12 10-10-10	1500 LBS./AC. 1000 LBS./AC. 400 LBS./AC.	50-100 LBS./AC. 1/ 2/ 30
2.	COOL SEASON GRASSES AND LEGUMES	FIRST SECOND MAINTENANCE	6-12-12 0-10-10 0-10-10	1500 LBS./AC. 1000 LBS./AC. 400 LBS./AC.	0-50 LBS./AC. 1/
3.	GROUND COVERS	FIRST SECOND MAINTENANCE	10-10-10 10-10-10 10-10-10	1300 LBS./AC. 3/ 1300 LBS./AC. 3/ 1100 LBS./AC.	
4.	PINE SEEDLINGS	FIRST	20-10-5	ONE 21-GRAM PELLET PER SEEDLING PLACED IN THE CLOSING HOLE	-
5.	SHRUB LESPEDEZA	FIRST MAINTENANCE	0-10-10 0-10-10	700 LBS./AC. 700 LBS./AC. 4/	
6.	TEMPORARY COVER CROPS SEEDED ALONE	FIRST	10-10-10	500 LBS./AC.	30 LBS./AC. 5/
7.	WARM SEASON GRASSES	FIRST SECOND MAINTENANCE	6-12-12 6-12-12 10-10-10	1500 LBS./AC. 800 LBS./AC. 400 LBS./AC.	50-100 LBS./AC. 2/ 6/ 50-100 LBS./AC. 2/ 30 LBS./AC.
8.	WARM SEASON GRASSES AND LEGUMES	FIRST SECOND MAINTENANCE	6-12-12 0-10-10 0-10-10	1500 LBS./AC. 1000 LBS./AC. 400 LBS./AC.	50 LBS./AC. 6/

1/ APPLY IN SPRING FOLLOWING SEEDING. 2/ APPLY IN SPLIT APPLICATIONS WHEN HIGH RATES ARE USED.

3/ APPLY IN 3 SPLIT APPLICATIONS.

4/ APPLY WHEN PLANTS ARE PRUNED.

APPLY TO GRASS SPECIES ONLY 6/ APPLY WHEN PLANTS GROW TO A HEIGHT OF 2 TO 4 INCHES.


USE AND MANAGEMENT: MOW SERICEA LESPEDEZA ONLY AFTER FROST TO ENSURE THAT HE SEEDS ARE MATURE. MOW BETWEEN NOVEMBER AND MARCH. BERMUDAGRASS, BAHIAGRASS AND TALL FESCUE MAY BE MOWED AS DESIRED. MAINTAIN AT LEAST 6 INCHES OF TOP GROWTH UNDER ANY USE AND MANAGEMENT. MODERATE USE OF TOP GROWTH IS BENEFICIAL AFTER ESTABLISHMENT. EXCLUDE TRAFFIC UNTIL THE PLANTS ARE WELL ESTABLISHED. BECAUSE OF THE QUAIL NESTING SEASON, MOWING SHOULD NOT TAKE PLACE BETWEEN MAY AND SEPTEMBER.

	PLANTING DATES BY RESOURCE AREAS																	
SPECIES	BROADCAST RESOURCE RATES 1/ - PLS 2/ AREA 3/			PLANTING DATES											REMARKS			
	PER PER 1000 ACRE SO ET		(SO DOT MAF	TTE	D L	INE	SIN	DIC								JT		
	ACRE SQ. FT.		J	F	M	I A	М	J	J	J	Α	S	0	1	N	D		
LESPEDEZA AMBRO VIRGATA (LESPEDEZA VIRGATA DC) OR APPALOW (LESPEDEZA CUNEATA [DUMONT] G. DON) SCARIFIED UNSCARIFIED	60 LBS 1.4 LB 75 LBS 1.7 LB	M-L P C M-L P C		_	_			-									300,000 SEED PER POUND. HEIGHT OF GROWTH IS 18 TO 24 INCHES. ADVANTAGEOUS IN URBAN AREAS. SPREADING-TYPE GROWTH. NEW GROWTH HAS BRONZE COLORATION. MIX WITH WEEPING LOVEGRASS, COMMON BERMUDA, BAHIA, TALL FESCUE OR WINTER ANNUALS. DO NOT MIX WITH SERICEA LESPEDEZA. SLOW TO DEVELOP SOLID STANDS. INNOCULATE SEED WITH EL INNOCULANT.	
LESPEDEZA, SHRUB		M-L								†								
(LESPEDEZA BICOLOR) (LESPEDEZA THUMBERGII)	3' X 3'	P C			-									-			PROVIDE WILDLIFE FOOD AND COVER	
PLANTS																		
OVEGRASS, WEEPING ERAGROSTIS CURVULA) ALONE WITH OTHER PERENNIALS	4 LBS 0.1 LB 2 LBS 0.05 LB	M-L P C			_												1,500,000 SEED PER POUND. QUICK COVER. DROUGHT TOLERANT. GROWS WELL WITH SERICEA LESPEDEZA ON ROADBANKS	
MAIDENCANE (PANICUM HERMITOMON)	2' X 3' SPACING	ALL															FOR VERY WET SITES. MAY CLOG CHANNELS. DIG SPRIGS FROM LOCAL SOURCES. USE ALONG RIVER BANKS AND SHORELINES.	
SPRIGS PANICGRASS, ATLANTIC COASTAL (PANICUM AMARUM VAR. AMARULUM)	20 LBS 0.5 LB	P C															GROWS WELL ON COASTAL SAND DUNES, BORROW AREAS, AND GRAVEL PITS. PROVIDES WINTER COVER FOR WILDLIFE. MIX WITH SERICEA LESPEDEZA EXCEPT ON SAND DUNES	
REED CANARY GRASS (PHALARIS ARUNDINACEA) ALONE WITH OTHER	50 LBS 1.1 LB 30 LBS 0.7 LB	M-L P															GROWS SIMILAR TO TALL FESCUE	
PERENNIALS SUNFLOWER 'AZTEC' MAXIMILLIAN	10 LBS 0.2 LB	M-L P															227,000 SEED PER POUND. MIX WITH WEEPING LOVEGRASS	

DESIGN PROFESSIONAL CODY OWENBY, P.E. LEVEL II CERTIFICATION No.: 0000095439 EXPIRES: 09/10/2027

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CLIENT INFORMATION

FAYETTE COUNTY 140 STONEWALL AVE W, STE 203

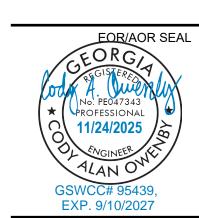FAYETTEVILLE, GA. 30214

PROJECT NAME

CROSS CREEK REPLACEMENT

FAYETTE COUNTY, GA

DRAWING ISSUE

MDW/MIA **DESIGNED BY:** DRAWN BY CHECKED BY: SUBMITTED BY:

SHEET TITLE

1210496

EROSION AND SEDIMENT CONTROL **DETAILS**

DATE: NOVEMBER 24, 2025

PROJECT #

SHEET NUMBER

CE503

SHEET 16 OF 20 **ORIGINAL SHEET SIZE:** 22" X 34"

SEEDING SCHEDULE PERMANENT COVER

PLANTS, PLANTING RATES, AND PLANTING DATES

MARGINAL DATES.)

PLANTING DATES BY RESOURCE AREAS

PLANTING DATES

DOTTED LINES INDICATE PERMISSIBLE BUT

J | F | M | A | M | J | J | A | S | O | N | D

(SOLID LINES INDICATE OPTIMUM DATES,

OR OTHER LOW-GROWING

GRASSES OR LEGUMES.

BLOCK SOD ONLY

PARTIAL SHADE, EFFECTIVE CONCENTRATED FLOW AREAS.

DROUGHT TOLERANT. FULL SUN OR ADJACENT TO CONCRETE AND IN IRRIGATION IS NEEDED UNTIL FULLY ESTABLISHED. DO NOT PLANT NEAR

SAME AS ABOVE

APPROXIMATELY 650 SPRIGS.


FEET OR APPROXIMATELY 800

A BUSHEL CONTAINS 1.25 CUBIC


PASTURES. WINTERHARDY AS FAR

SOUTHERN COASTAL PLAIN ONLY

NORTH AS ATHENS AND ATLANTA.

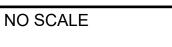

100% DESIGN ISSUED FOR CONSTRUCTION

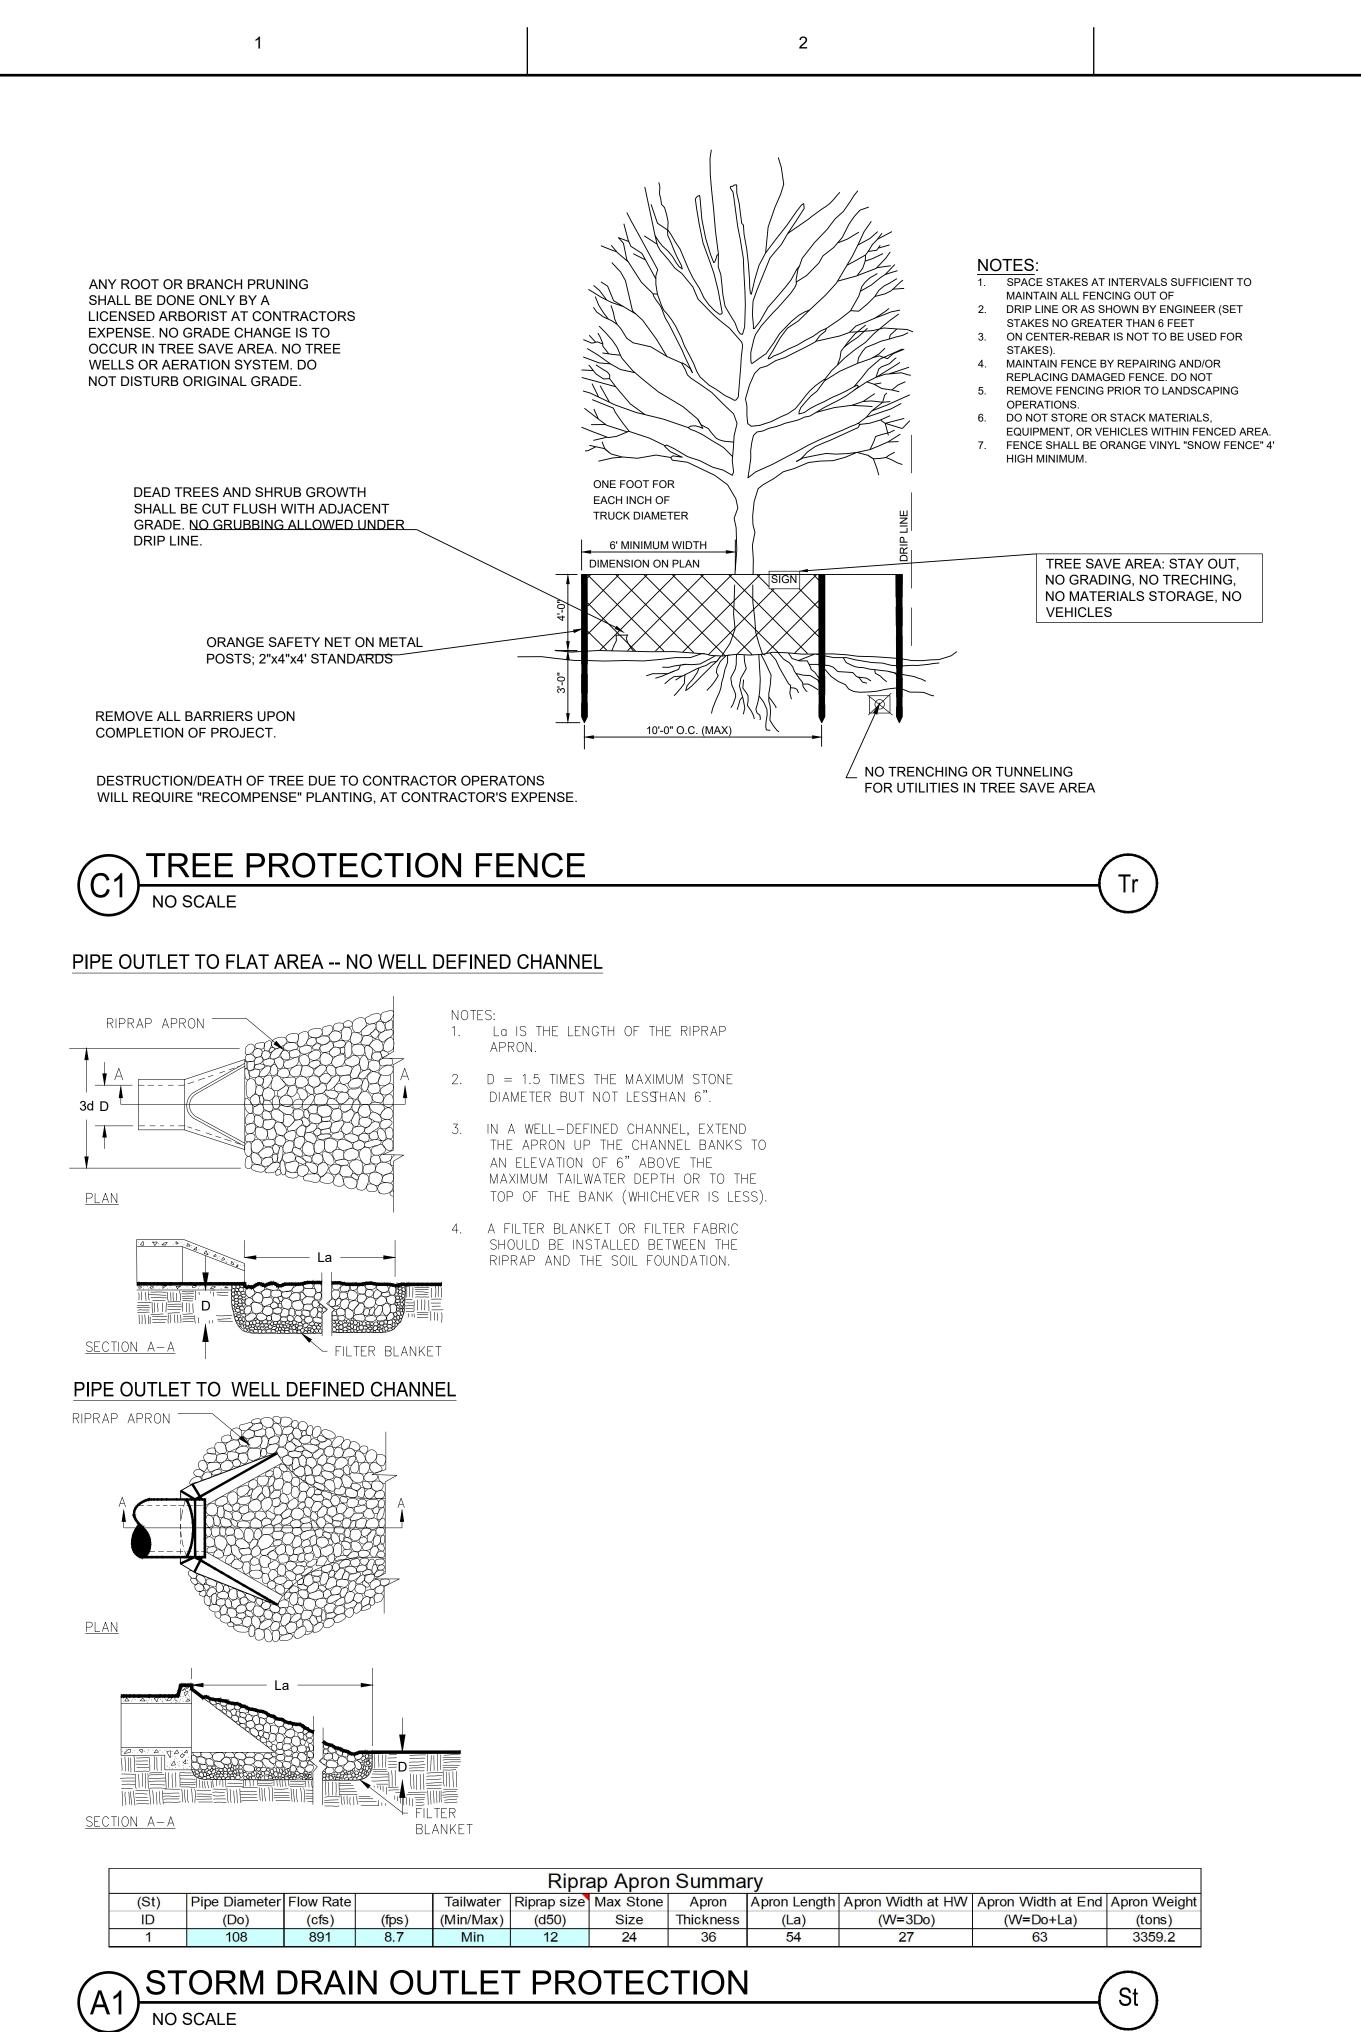

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Georgia 30092
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EOR/AOR SEAL

GEORG

WWW

No. PE047343

PROFESSIONAL

11/24/2025

ALAN O

GSWCC# 95439,

EXP. 9/10/2027

CLIENT INFORMATION

FAYETTE COUNTY

140 STONEWALL AVE W, STE 203 FAYETTEVILLE, GA. 30214

PROJECT NAME

CROSS CREEK TRAIL CULVERT REPLACEMENT

FAYETTE COUNTY, GA

DRAWING ISSUE

SCRIPTION

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DESIGNED BY: MDW/MIA
DRAWN BY: MDW
CHECKED BY: COA
SUBMITTED BY: TT
DATE: NOVEMBER 24, 2025
PROJECT # 1210496

SHEET TITLE


EROSION AND SEDIMENT CONTROL DETAILS

SHEET NUMBER


CE504

SHEET 17 OF 20


ORIGINAL SHEET SIZE:
22" X 34"

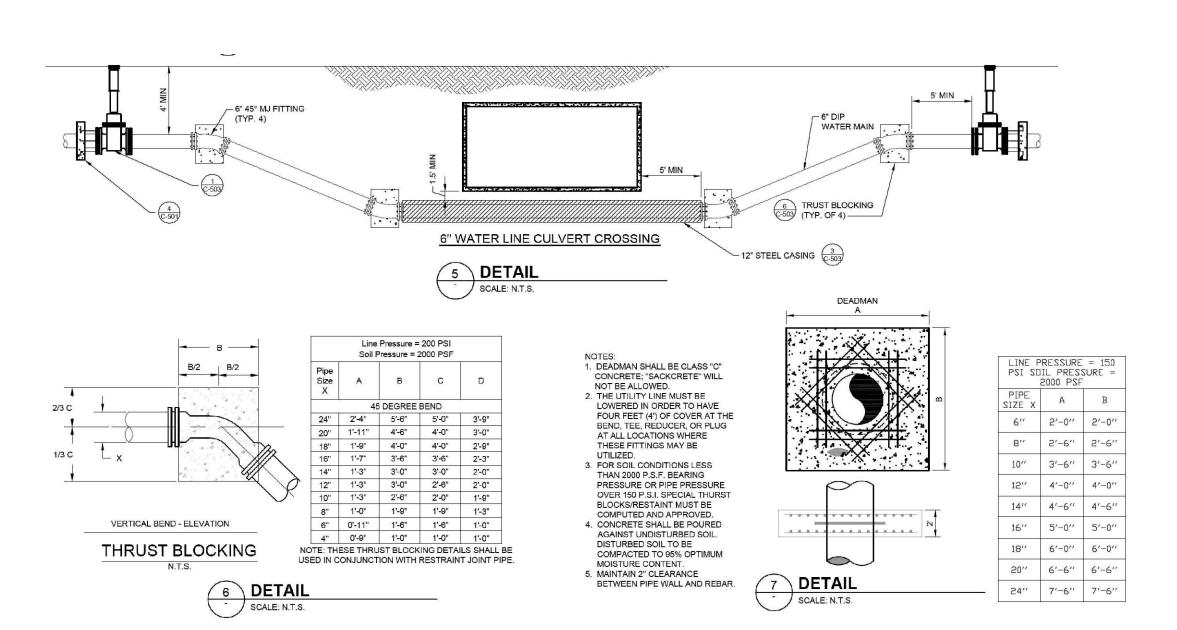

WATERLINE UNDER CULVERT DETAILS
NO SCALE

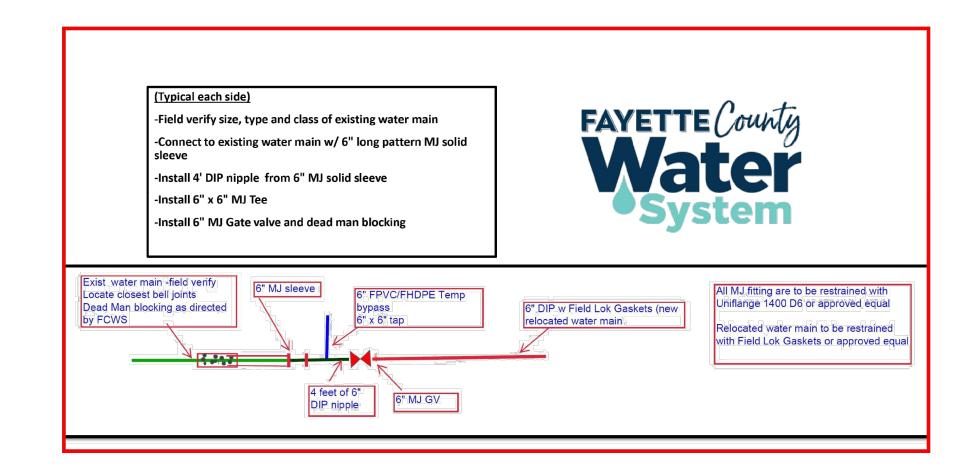

B1 FAYETTE COUNTY WATER DETAILS

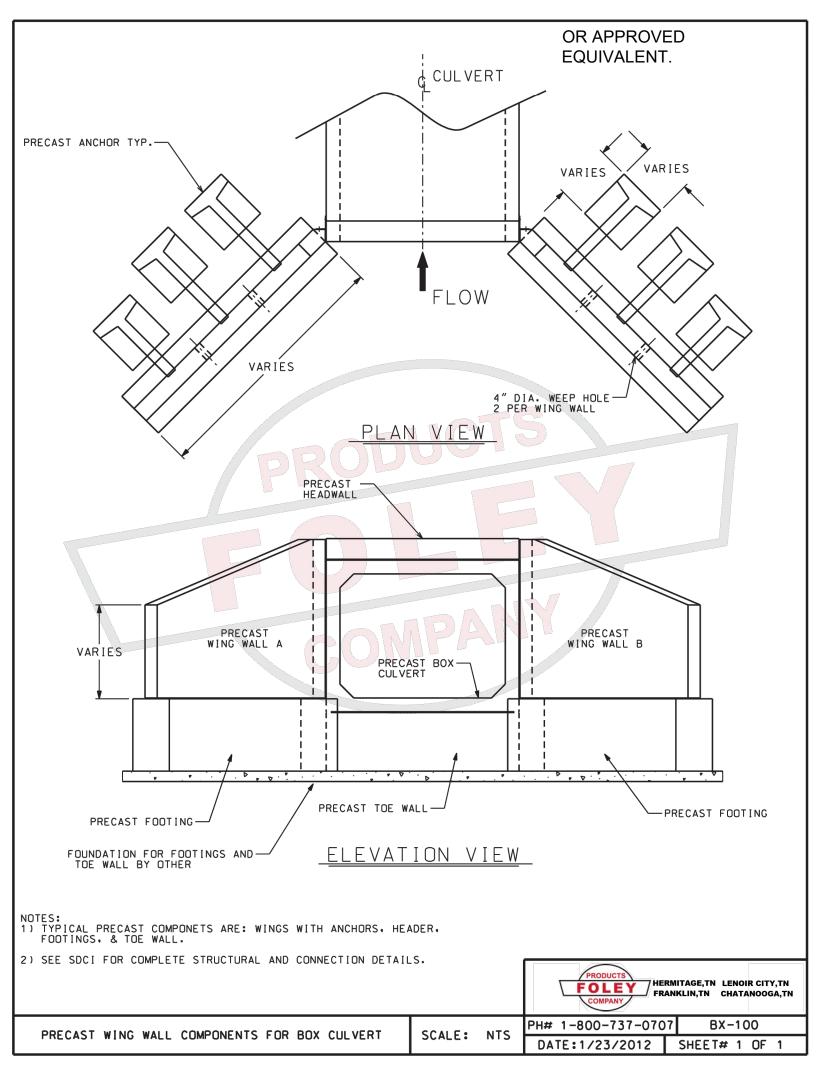

PRECAST WING WALL COMPONENT FOR BOX CULVERT
NO SCALE

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Georgia 30092
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FAYETTE COUNTY 140 STONEWALL AVE W, STE 203 FAYETTEVILLE, GA. 30214

PROJECT NAME

CROSS CREEK TRAIL CULVERT REPLACEMENT

FAYETTE COUNTY, GA

DRAWING ISSUE

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DESCRIPTIO

≥ W/MIA

DESIGNED BY: MDW/MIA

DRAWN BY: MDW

CHECKED BY: COA

SUBMITTED BY: TT

DATE: NOVEMBER 24, 2025

PROJECT # 1210496

SHEET TITLE

CONSTRUCTION DETAILS

SHEET NUMBER

C-501


SHEET 18 OF 20

ORIGINAL SHEET SIZE:
22" X 34"

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FAYETTE COUNTY 140 STONEWALL AVE W, STE 203 FAYETTEVILLE, GA. 30214

PROJECT NAME

CROSS CREEK TRAIL CULVERT REPLACEMENT

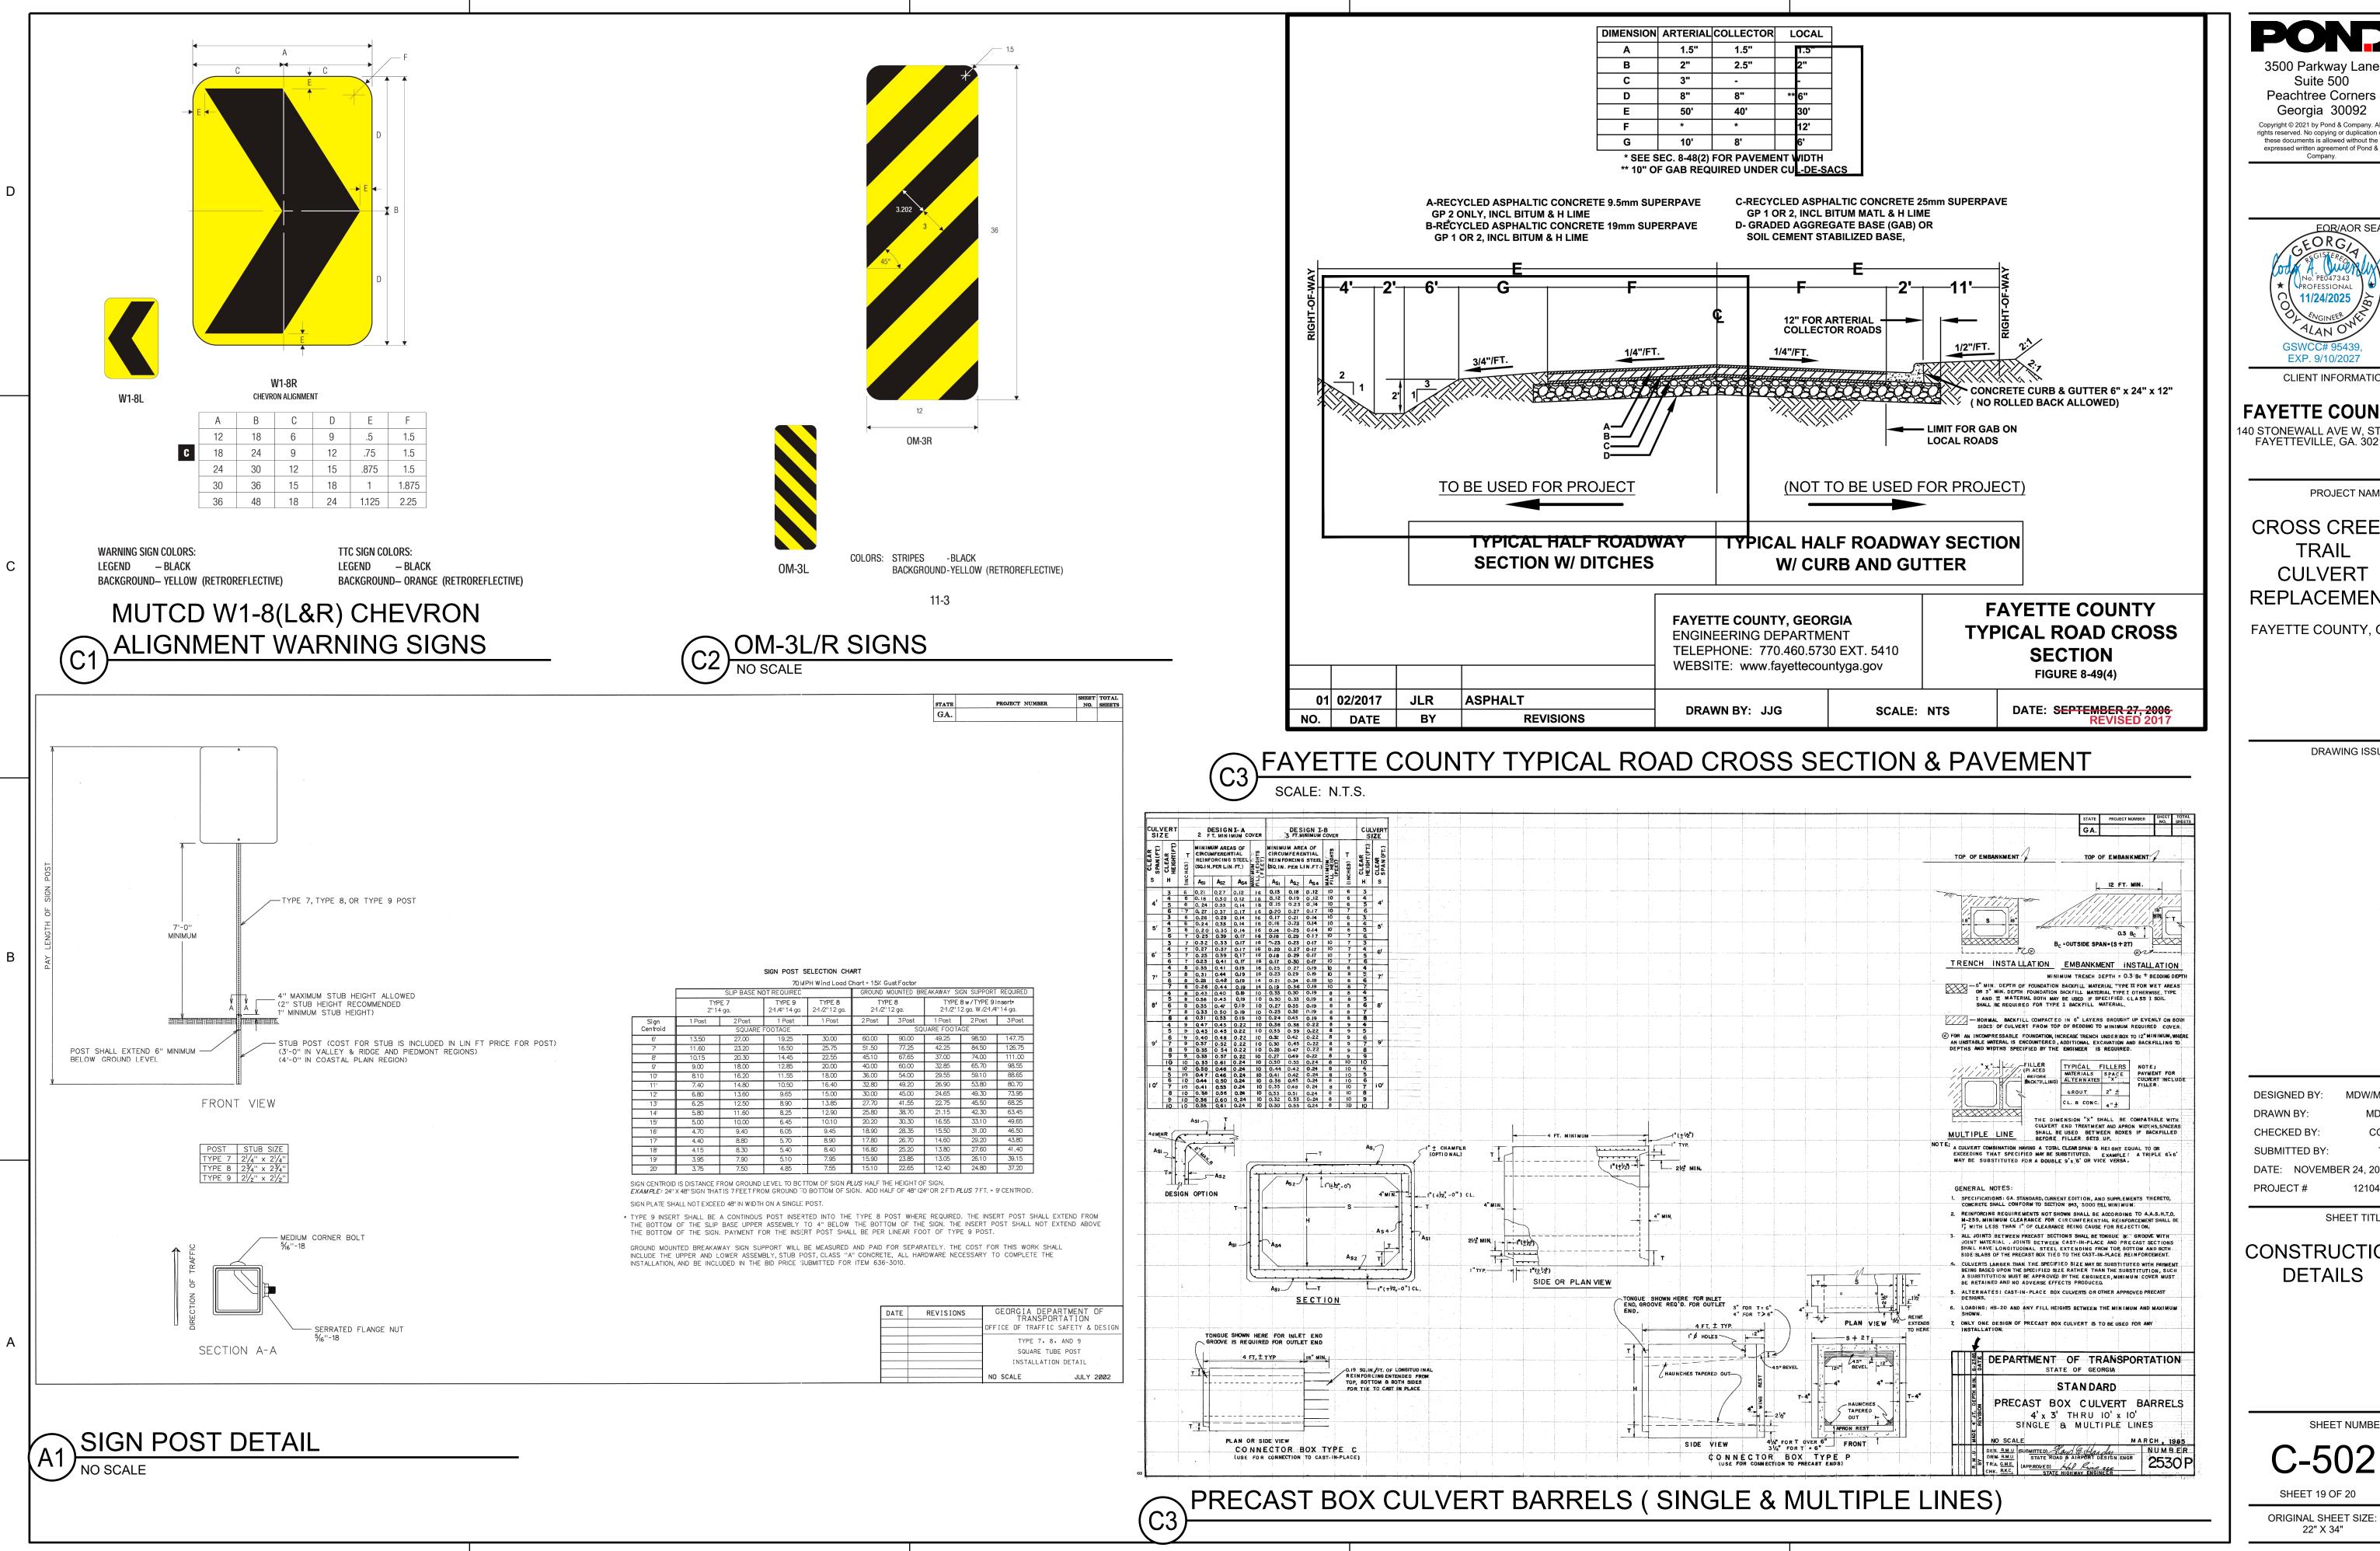FAYETTE COUNTY, GA

DRAWING ISSUE

MDW/MIA

DRAWN BY CHECKED BY: SUBMITTED BY: DATE: NOVEMBER 24, 2025

SHEET TITLE


1210496

CONSTRUCTION **DETAILS**

SHEET NUMBER

C-502

SHEET 19 OF 20 ORIGINAL SHEET SIZE: 22" X 34"

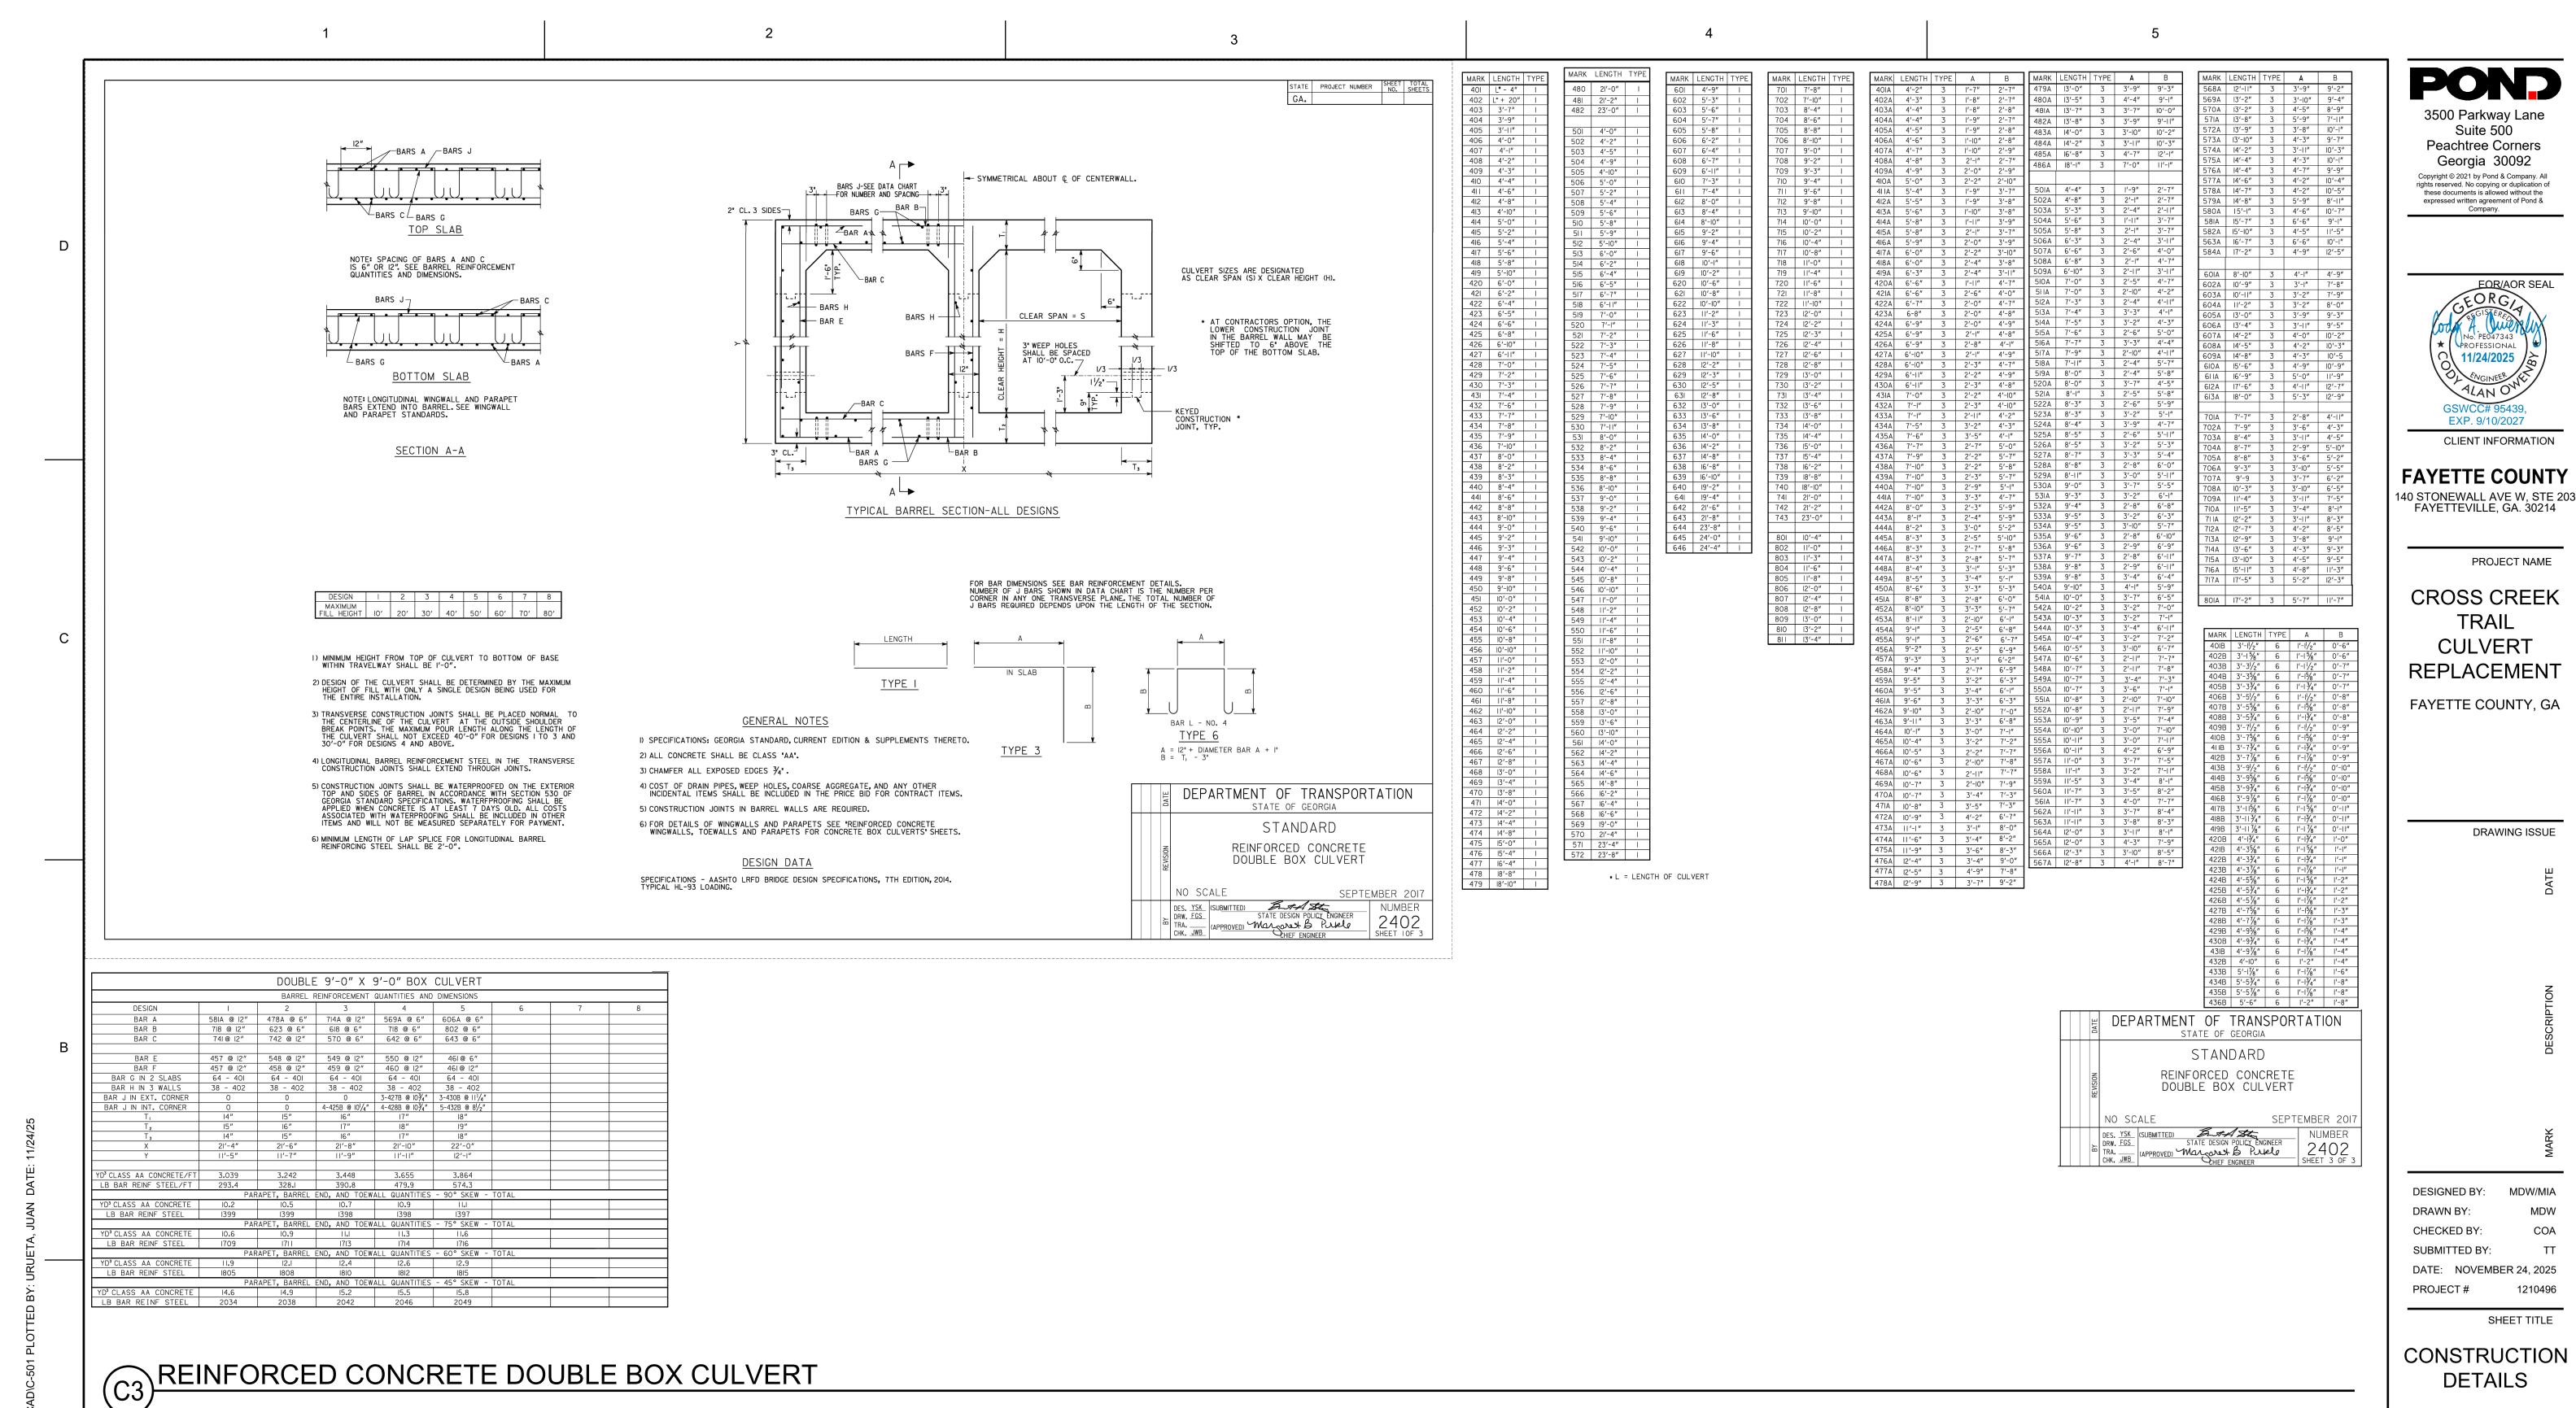

SHEET TITLE CONSTRUCTION **DETAILS**

DATE: NOVEMBER 24, 2025

DESIGNED BY:

DRAWN BY: CHECKED BY: SUBMITTED BY:

PROJECT#

MDW/MIA

3500 Parkway Lane Suite 500

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FAYETTEVILLE, GA. 30214

CROSS CREEK

CULVERT

REPLACEMENT

FAYETTE COUNTY, GA

PROJECT NAME

DRAWING ISSUE

CLIENT INFORMATION

SHEET NUMBER

C-503

SHEET 20 OF 20

ORIGINAL SHEET SIZE: 22" X 34"